

# MASSACHUSETTS BAY TRANSPORTATION AUTHORITY

## SALEM COMMUTER RAIL STATION INTERMODAL CENTER

### SALEM, MASSACHUSETTS

#### 30% DESIGN SUBMISSION - DECEMBER 16, 2009

**AECOM**

PRIME / ARCHITECTURE  
38 Chauncy Street, 10th Floor, Suite 1001,  
Boston, MA 02111  
Tel: 617.482.4835 Fax: 617.482.0642

*Moving Massachusetts Forward.*  
**massDOT**

**STRUCTURAL ENGINEER**

Walker Parking Consultants  
20 Park Plaza, Suite 1202  
Boston, MA 02116  
Tel: 617.350.5040 Fax: 617.350.5048

**ENVIRONMENTAL ENGINEER**

AECOM Environmental  
95 State Road  
Sagamore Beach, MA 02562  
Tel: 508.888.3900 Fax: 508.888.6689

**MEP / FP / IT ENGINEER**

Architectural Engineers, Inc.  
77 Summer Street  
Boston, MA 02110  
Tel: 617.542.0810 Fax: 617.542.8451

**COST ESTIMATOR**

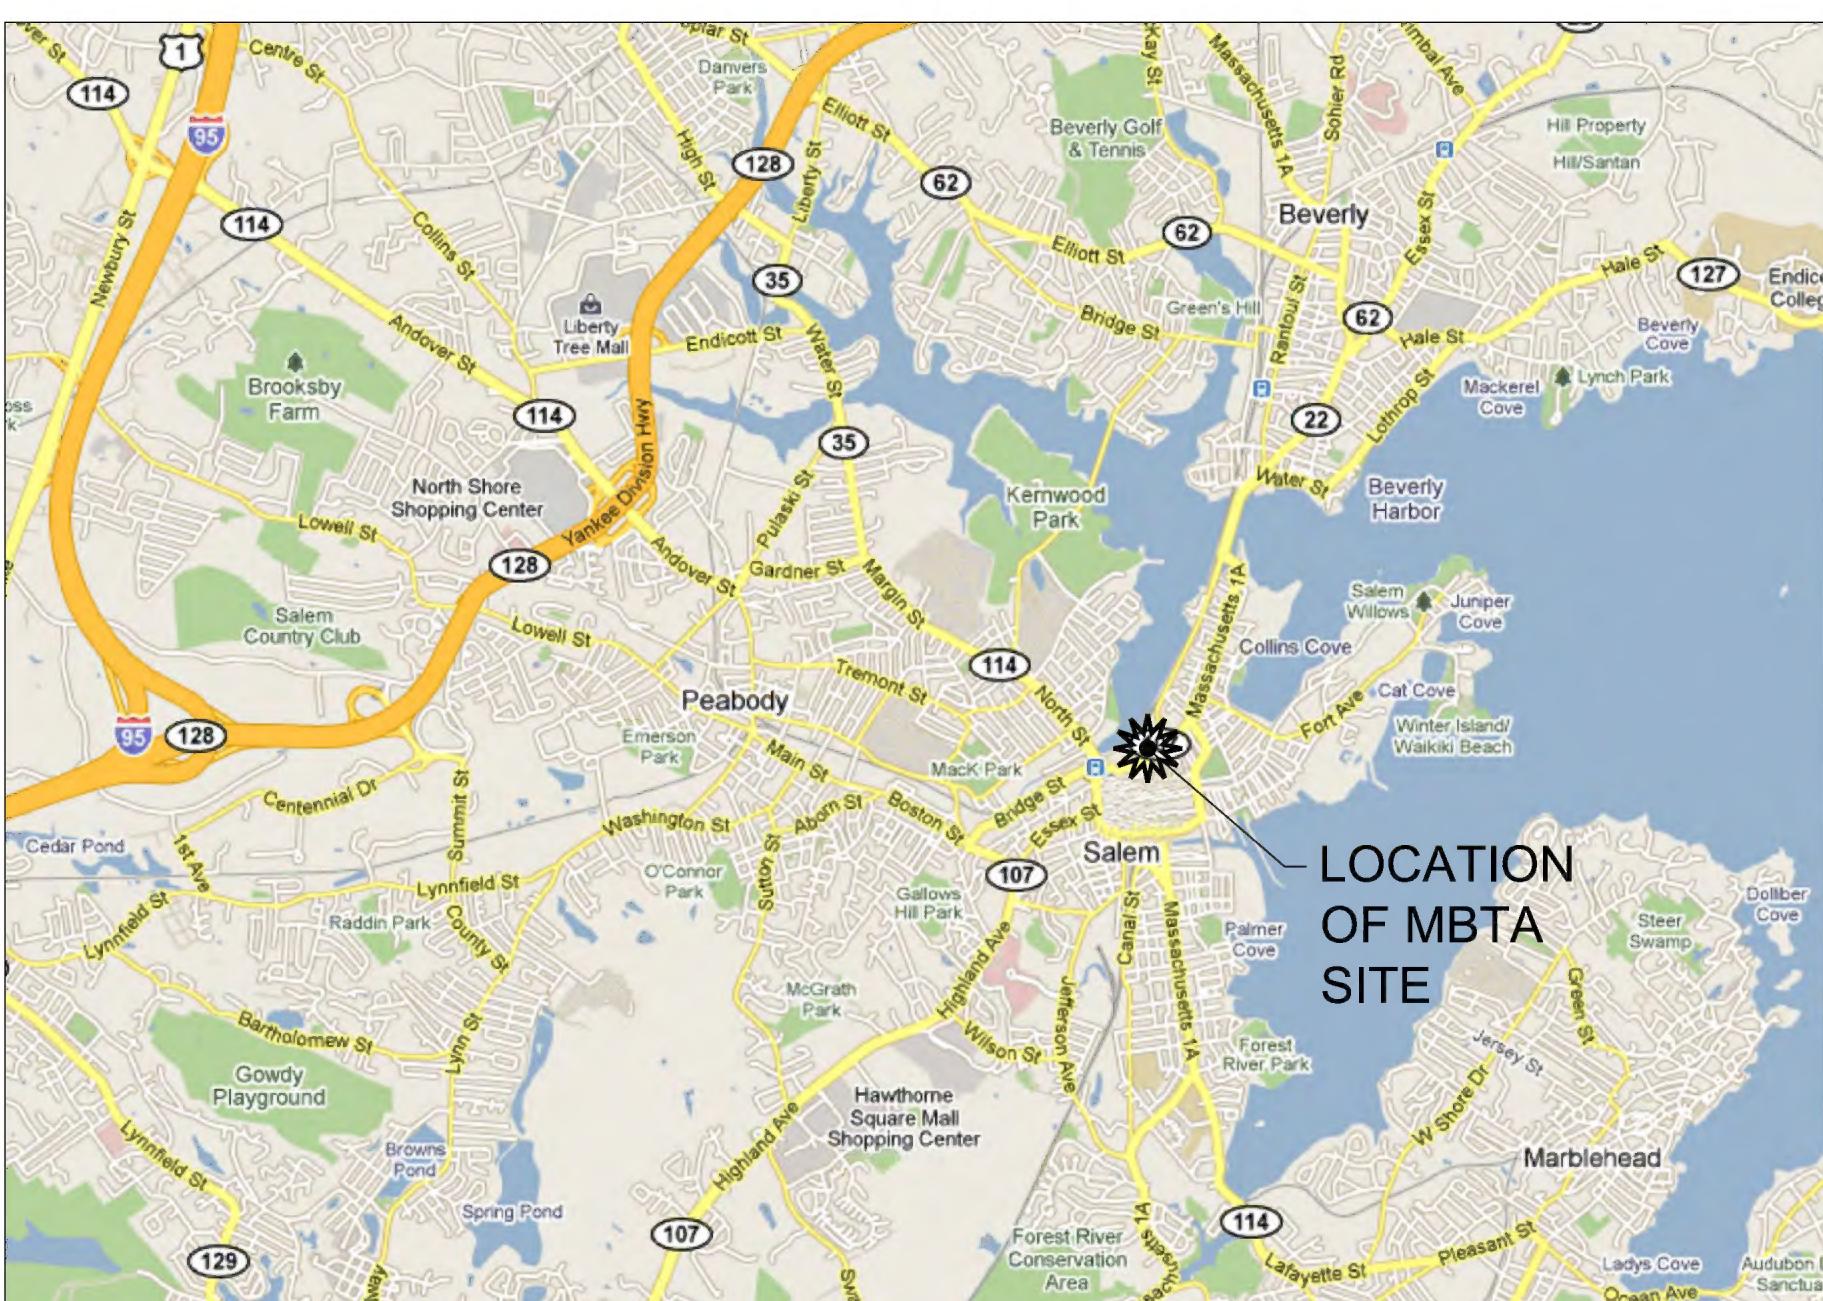
Keville Enterprises, Inc.  
145 Tremont Street, 3rd Floor  
Boston, MA 02111  
Tel: 617.482.3888 Fax: 617.482.4488

**CIVIL ENGINEER**

Lin Associates, Inc.  
2001 Beacon St.  
Brighton MA 02135  
Tel: 617.566.4216 Fax: 617.566.6038

**RAIL ENGINEER**

SYSTRA  
38 Chauncy Street, Suite 805  
Boston, MA 02111  
Tel: 617.423.3777 Fax: 617.423.4161


**LOCUS MAP:****VICINITY MAP:****MBTA**

Massachusetts Bay Transportation Authority  
10 Park Plaza, Room 5750  
Boston, MA 02116 Tel: 617.222.4400

500 Arborway  
Jamaica Plain, MA 02130 Tel: 617.222.3082 Fax: 617.222.4535

MASSACHUSETTS BAY  
TRANSPORTATION AUTHORITY

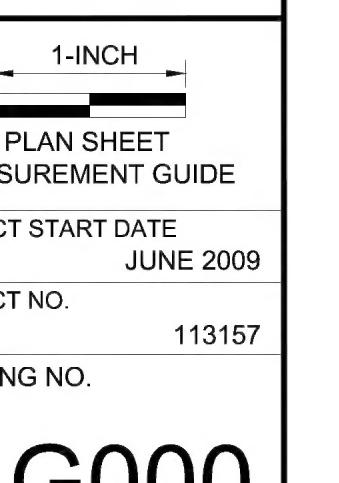APPROVED \_\_\_\_\_ DIRECTOR  
DATE \_\_\_\_\_ PLANNING & DEVELOPMENT  
APPROVED \_\_\_\_\_ PROJECT MANAGER  
DATE \_\_\_\_\_ DESIGN & CONSTRUCTION  
DEPARTMENT

REV	DESCRIPTION	DRN	CHK	DATE	STAMP:
1	30% DESIGN SUBMISSION	JG	JK	12/16/2009	 1-INCH PLAN SHEET MEASUREMENT GUIDE PROJECT START DATE JUNE 2009 PROJECT NO. 113157 DRAWING NO. G000

## INDEX OF DRAWINGS

- INDICATES PACKAGE OR ADDENDUM THAT DRAWING WAS ISSUED OR RE-ISSUED FOR REFERENCE
- INDICATES PACKAGE OR ADDENDUM THAT DRAWING WAS ISSUED OR RE-ISSUED FOR CONSTRUCTION
- R INDICATES DRAWING WAS REVISED BUT NOT RE-ISSUED AS A FULL SHEET IN THIS PACKAGE OR ADDENDUM
- REVISION OR ADDENDUM

### VOLUME 1

SHEET

TITLE

#### GENERAL DRAWINGS

G000	TITLE SHEET	<input type="radio"/>
G001	SHEET INDEX	<input type="radio"/>
G002	CODE ANALYSIS / LIFE SAFETY PLANS	<input type="radio"/>
G003	GENERAL NOTES AND ABBREVIATIONS	<input type="radio"/>
G004	PARTITION TYPES	<input type="radio"/>

#### CIVIL DRAWINGS

C001	EXISTING CONDITIONS	<input type="radio"/>
C002	DEMOLITION PLAN	<input type="radio"/>
C003	PROPOSED SITE PLAN	<input type="radio"/>
C004	PROPOSED GRADING AND DRAINAGE PLAN	<input type="radio"/>
C005	PROPOSED UTILITY PLAN	<input type="radio"/>
C006	DETAIL SHEET 1	<input type="radio"/>
C007	DETAIL SHEET 2	<input type="radio"/>

#### ARCHITECTURAL DRAWINGS

A100	LOWER SITE PLAN	<input type="radio"/>
A101	UPPER SITE PLAN	<input type="radio"/>
A200	FIRST FLOOR PLAN	<input type="radio"/>
A201	SECOND FLOOR PLAN	<input type="radio"/>
A202	THIRD FLOOR PLAN	<input type="radio"/>
A203	FOURTH FLOOR PLAN	<input type="radio"/>
A204	FIFTH FLOOR PLAN	<input type="radio"/>
A205	SIXTH FLOOR PLAN	<input type="radio"/>
A206	ROOF PLAN	<input type="radio"/>
A300	FIRST FLOOR REFLECTED CEILING PLAN	<input type="radio"/>
A301	SECOND FLOOR REFLECTED CEILING PLAN	<input type="radio"/>
A302	THIRD FLOOR REFLECTED CEILING PLAN	<input type="radio"/>
A303	FOURTH FLOOR REFLECTED CEILING PLAN	<input type="radio"/>
A304	FIFTH FLOOR REFLECTED CEILING PLAN	<input type="radio"/>
A305	SIXTH FLOOR REFLECTED CEILING PLAN	<input type="radio"/>
A400	EXTERIOR ELEVATIONS	<input type="radio"/>
A401	EXTERIOR ELEVATIONS	<input type="radio"/>
A500	BUILDING SECTIONS	<input type="radio"/>
A501	BUILDING SECTIONS	<input type="radio"/>

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### VOLUME 1

SHEET

TITLE

#### STRUCTURAL DRAWINGS

S001	STRUCTURAL GENERAL NOTES	<input type="radio"/>
S002	TYPICAL DETAILS	<input type="radio"/>
S100	FOUNDATION PLAN AND LEGEND	<input type="radio"/>
S100.1	FOUNDATION DETAILS AND SCHEDULES	<input type="radio"/>
S100.2	FOUNDATION WALL DETAILS	<input type="radio"/>
S101	LEVEL 1 PLAN	<input type="radio"/>
S102	LEVEL 2 PLAN	<input type="radio"/>
S103	LEVEL 3 PLAN	<input type="radio"/>
S104	LEVEL 4 PLAN	<input type="radio"/>
S105	LEVEL 5 PLAN	<input type="radio"/>
S106	TOP LEVEL PLAN	<input type="radio"/>
S211	LIGHTWALL PLANS, ELEVATIONS, AND DETAILS	<input type="radio"/>
S221	SHEARWALL PLANS, ELEVATIONS, AND DETAILS	<input type="radio"/>
S401	P/C COLUMN DETAILS AND NOTES	<input type="radio"/>
S410	ENLARGED STAIR NO. 1 PLANS	<input type="radio"/>
S411	ENLARGED STAIR NO. 1 PLANS	<input type="radio"/>
S420	ENLARGED STAIR NO. 2 PLANS	<input type="radio"/>
S430	ENLARGED STAIR NO. 3 PLANS	<input type="radio"/>
S440	CONNECTOR BRIDGE	<input type="radio"/>
S510	P/C COLUMN DETAILS AND NOTES	<input type="radio"/>
S511	P/C TEE DETAILS AND NOTES	<input type="radio"/>
S521	P/C STRUCTURAL DETAILS AND NOTES	<input type="radio"/>
S801	P/C TEE DETAILS AND NOTES	<input type="radio"/>

#### MECHANICAL DRAWINGS

M001	MECHANICAL LEGEND	<input type="radio"/>
M101	MECHANICAL FIRST LEVEL PLAN	<input type="radio"/>
M102	MECHANICAL SECOND LEVEL PLAN	<input type="radio"/>
M103	MECHANICAL THIRD LEVEL PLAN	<input type="radio"/>
M104	MECHANICAL FOURTH LEVEL PLAN	<input type="radio"/>
M105	MECHANICAL FIFTH LEVEL PLAN	<input type="radio"/>
M106	MECHANICAL SIXTH LEVEL PLAN	<input type="radio"/>
M107	MECHANICAL SCHEDULES	<input type="radio"/>

#### PLUMBING DRAWINGS

P001	PLUMBING LEGEND	<input type="radio"/>
P101	PLUMBING GROUND LEVEL PLAN	<input type="radio"/>
P102	PLUMBING 2ND LEVEL PLAN	<input type="radio"/>
P103	PLUMBING 3RD LEVEL PLAN	<input type="radio"/>
P104	PLUMBING 4TH LEVEL PLAN	<input type="radio"/>
P105	PLUMBING 5TH LEVEL PLAN	<input type="radio"/>
P106	PLUMBING 6TH LEVEL PLAN	<input type="radio"/>

#### FIRE PROTECTION DRAWINGS

F001	FIRE PROTECTION LEGEND	<input type="radio"/>
F101	FIRE PROTECTION FIRST LEVEL PLAN	<input type="radio"/>
F102	FIRE PROTECTION 2ND LEVEL PLAN	<input type="radio"/>
F103	FIRE PROTECTION 3RD LEVEL PLAN	<input type="radio"/>
F104	FIRE PROTECTION 4TH LEVEL PLAN	<input type="radio"/>
F105	FIRE PROTECTION 5TH LEVEL PLAN	<input type="radio"/>
F106	FIRE PROTECTION 6TH LEVEL PLAN	<input type="radio"/>

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### VOLUME 1

SHEET

TITLE

#### ELECTRICAL DRAWINGS

E001	ELECTRICAL LEGEND	<input type="radio"/>
E100	ELECTRICAL SITE PLAN	<input type="radio"/>
E101	ELECTRICAL FIRST LEVEL LIGHTING PLAN	<input type="radio"/>
E102	ELECTRICAL SECOND LEVEL LIGHTING PLAN	<input type="radio"/>
E103	ELECTRICAL THIRD LEVEL LIGHTING PLAN	<input type="radio"/>
E104	ELECTRICAL FOURTH LEVEL LIGHTING PLAN	<input type="radio"/>
E105	ELECTRICAL FIFTH LEVEL LIGHTING PLAN	<input type="radio"/>
E106	ELECTRICAL SIXTH LEVEL LIGHTING PLAN	<input type="radio"/>
E201	ELECTRICAL FIRST LEVEL POWER PLAN	<input type="radio"/>
E202	ELECTRICAL SECOND LEVEL POWER PLAN	<input type="radio"/>
E203	ELECTRICAL THIRD LEVEL POWER PLAN	<input type="radio"/>
E204	ELECTRICAL FOURTH LEVEL POWER PLAN	<input type="radio"/>
E205	ELECTRICAL FIFTH LEVEL POWER PLAN	<input type="radio"/>
E206	ELECTRICAL SIXTH LEVEL POWER PLAN	<input type="radio"/>
E300	ELECTRICAL RISER DIAGRAMS	<input type="radio"/>
E301	ELECTRICAL PANELBOARDS	<input type="radio"/>
E302	ELECTRICAL SCHEDULES, RISER DIAGRAMS, & DETAILS	<input type="radio"/>
E303	ELECTRICAL DETAILS	<input type="radio"/>

MASSACHUSETTS BAY TRANSPORTATION AUTHORITY  
SALEM COMMUTER RAIL STATION INTERMODAL CENTER  
SALEM, MASSACHUSETTS

SHEET INDEX

1	30% DESIGN SUBMISSION								
MLH	JK								
12/16/2009	12/16/2009	12/16/2009	12/16/2009	12/16/2009	12/16/2009	12/16/2009	12/16/2009	12/16/2009	12/16/2009
DATE	DATE								
REVISION	REVISION								
REV.	REV.								

1-INCH  
PLAN SHEET  
MEASUREMENT GUIDE  
PROJECT START DATE JUNE 2009  
PROJECT NO. 113157  
DRAWING NO. G001

AECOM

38 CHAUNCEY STREET  
TENTH FLOOR SUITE 1001  
BOSTON, MASSACHUSETTS 02111  
617.482.4835

# CODE ANALYSIS

APPLICABLE CODES:	
BUILDING:	780 CMR: MASS STATE BUILDING CODE -7TH ED. (2003 INTERNATIONAL BUILDING CODE) (2003 INTERNATIONAL FIRE CODE WHERE REFERENCED)
FIRE PREVENTION:	527 CMR: MASSACHUSETTS FIRE PREVENTION REGULATIONS
ACCESSIBILITY:	527 CMR: MASSACHUSETTS ARCHITECTURAL ACCESS BOARD REGULATIONS
ELECTRICAL:	527 CMR 12.00: MASSACHUSETTS STATE ELECTRICAL CODE (2008 NATIONAL ELECTRICAL CODE)
ELEVATOR:	524 CMR: MASSACHUSETTS ELEVATOR CODE (2004 ASME A17.1)
MECHANICAL:	2003 INTERNATIONAL MECHANICAL CODE (IMC)
PLUMBING:	248 CMR: MASSACHUSETTS PLUMBING CODE

GENERAL BUILDING LIMITATIONS: HEIGHT & AREA LIMITATIONS: NEW GARAGE BUILT OF TYPE 1B CONSTRUCTION: USE GROUP S2, LOW-HAZARD STORAGE		
CODE REFERENCE		CONSTRUCTIONS TYPE 2B
	HEIGHT	AREA (PER STORY)
TABLE 406.3.5	12 STORIES	UNLIMITED
--	--	--
--	--	--
--	--	--
--	--	N/A < 2 STORY
TOTAL ALLOWED	12 STORIES	UNLIMITED
PROPOSED HEIGHT & TOTAL AREA	6 STORIES (66')	60,000 SF

MEANS OF EGRESS:			
FLOOR	OCCUPANT LOAD	NUMBER OF EXITS REQUIRED	NUMBER OF EXITS PROVIDED
1	443	2	3
2	325	2	3
3	325	2	3
4	325	2	3
5	325	2	3
6	225	2	3

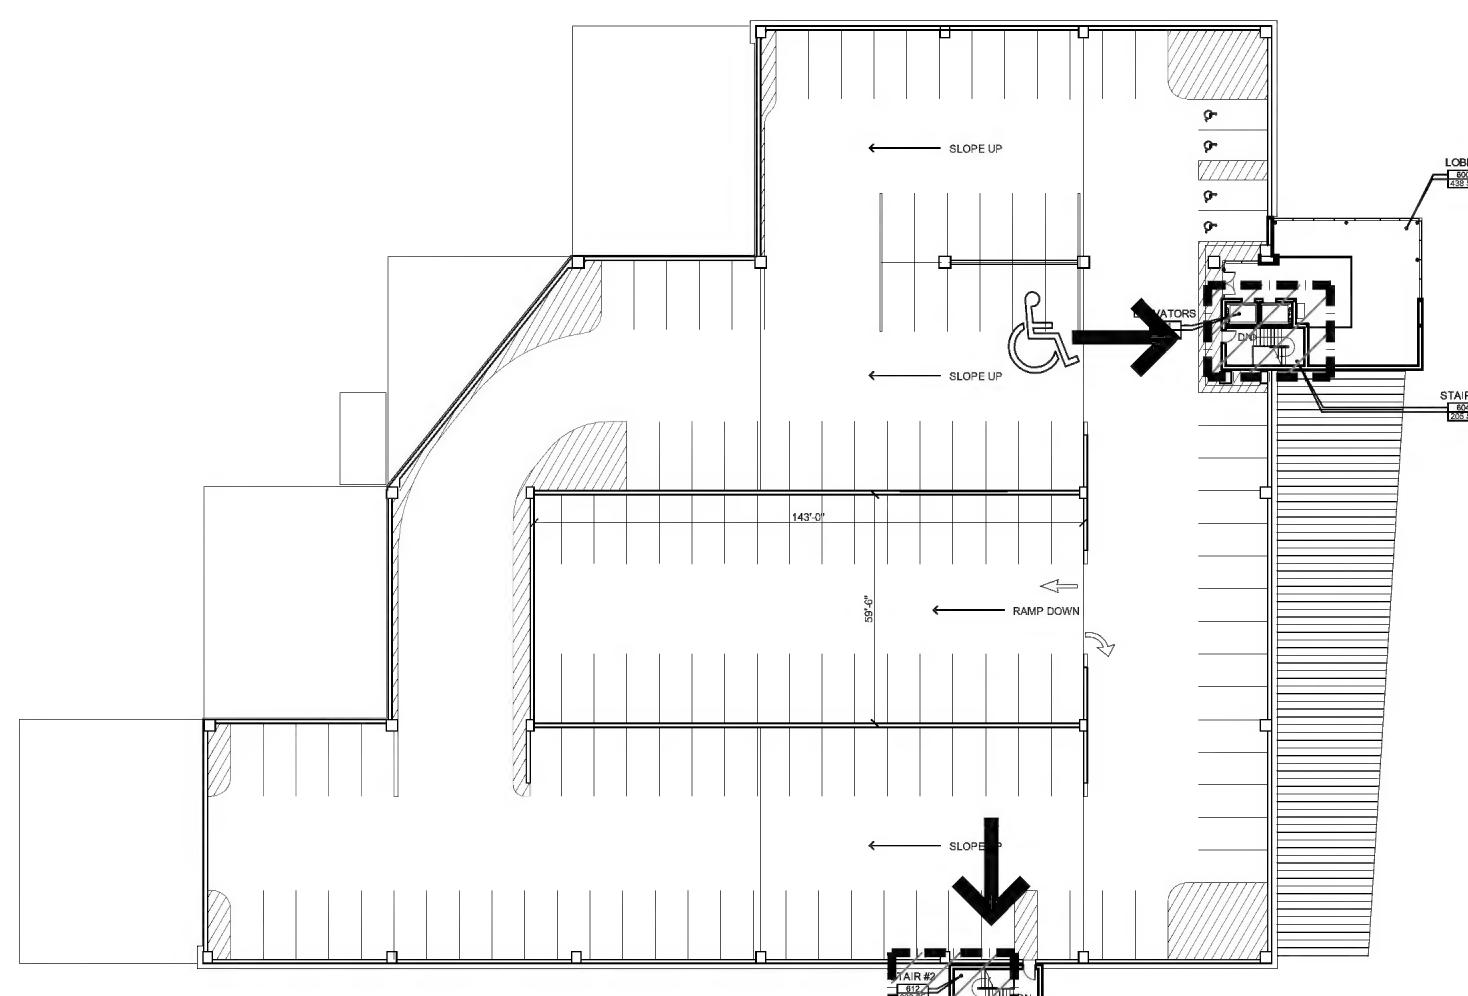
  

PROVIDED PLUMBING FIXTURES:		
	REQUIRED	PROVIDED
WATER CLOSETS	0	1
LAVATORIES	0	1


USES & OCCUPANCY CLASSIFICATION (NON-SEPARATED MIXED USE 780 CMR 313.0)			
FLOOR	AREA	780 CMR USE GROUP	NFPA 101 OCCUPANCY
1	NEW	S-2	STORAGE / ASSEMBLY
2	NEW	S-2	STORAGE
3	NEW	S-2	STORAGE
4	NEW	S-2	STORAGE
5	NEW	S-2	STORAGE
6	NEW	S-2	STORAGE

FIRE SEPARATION ASSEMBLY IS NOT REQUIRED BETWEEN USE GROUPS, EXCEPT AS REQUIRED BY OTHER SECTIONS


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ML	JK	ML	JK
DRN	CRN	DRN	CRN
REV.	REV.	REV.	REV.
1	30% DESIGN SUBMISSION	1	30% DESIGN SUBMISSION
STAMP:	CONSULTANT:	STAMP:	CONSULTANT:
AECOM		AECOM	
38 CHAUNCEY STREET TENTH FLOOR, SUITE 1001 BOSTON, MASSACHUSETTS 02111 617.482.4835		38 CHAUNCEY STREET TENTH FLOOR, SUITE 1001 BOSTON, MASSACHUSETTS 02111 617.482.4835	
CODE ANALYSIS / LIFE SAFETY PLANS		CODE ANALYSIS / LIFE SAFETY PLANS	
MASSACHUSETTS BAY TRANSPORTATION AUTHORITY SALEM COMMUTER RAIL STATION INTERMODAL CENTER SALEM, MASSACHUSETTS		MASSACHUSETTS BAY TRANSPORTATION AUTHORITY SALEM COMMUTER RAIL STATION INTERMODAL CENTER SALEM, MASSACHUSETTS	
1-INCH		1-INCH	
PLAN SHEET MEASUREMENT GUIDE		PLAN SHEET MEASUREMENT GUIDE	
PROJECT START DATE JUNE 2009		PROJECT START DATE JUNE 2009	
PROJECT NO. 113157		PROJECT NO. 113157	
DRAWING NO. G002		DRAWING NO. G002	




6 | SIXTH FLOOR EGRESS PLAN

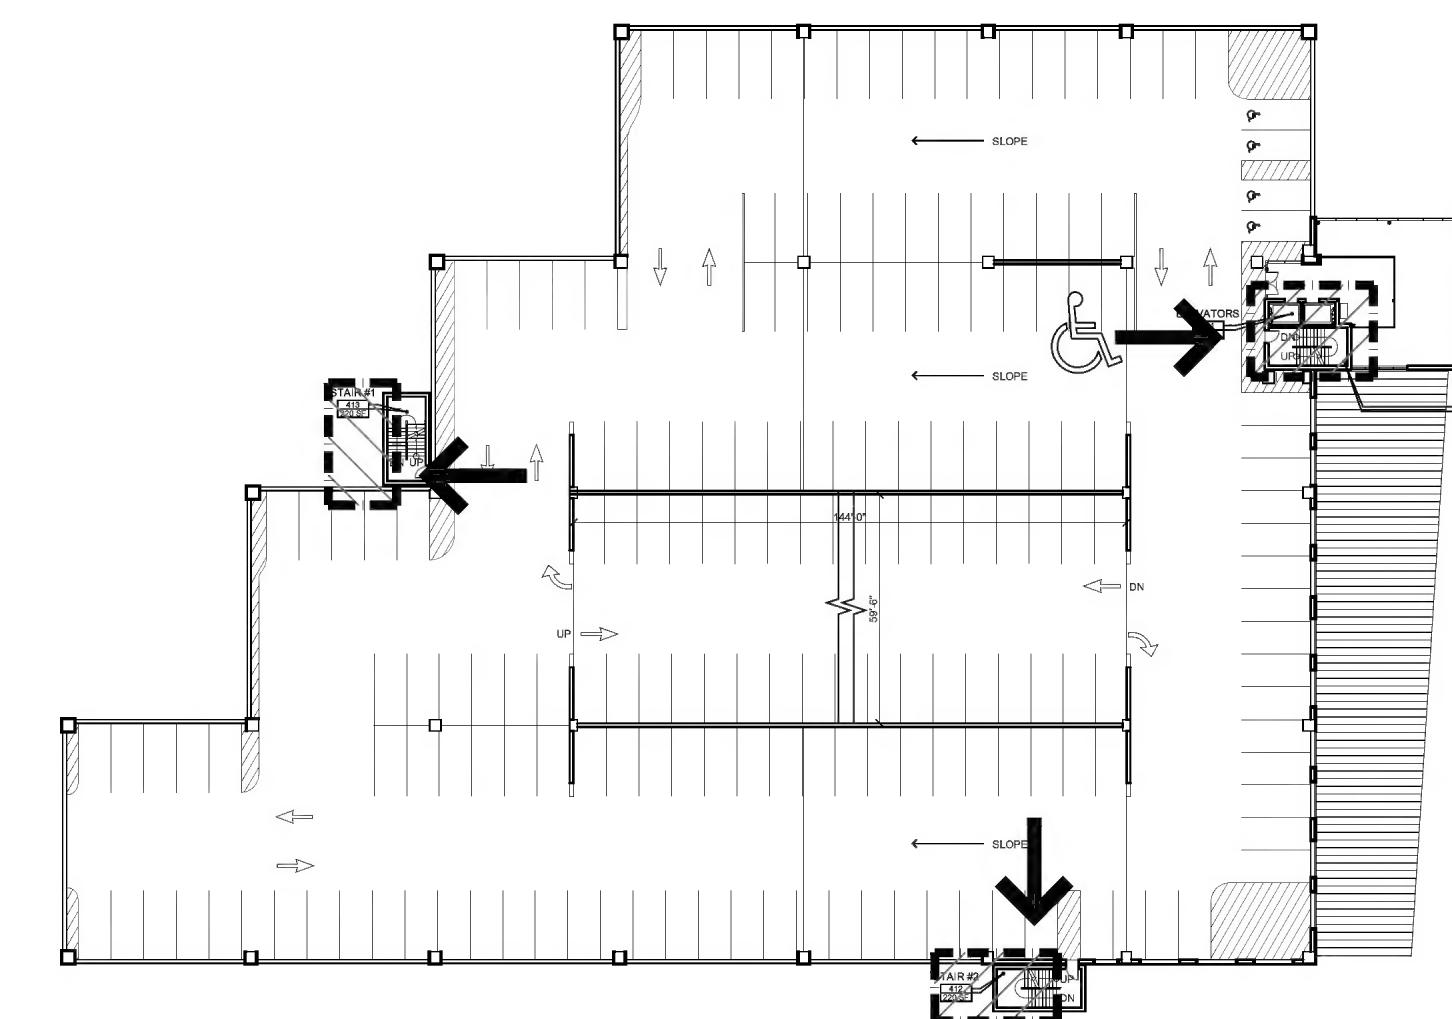


4 | FOURTH FLOOR EGRESS PLAN

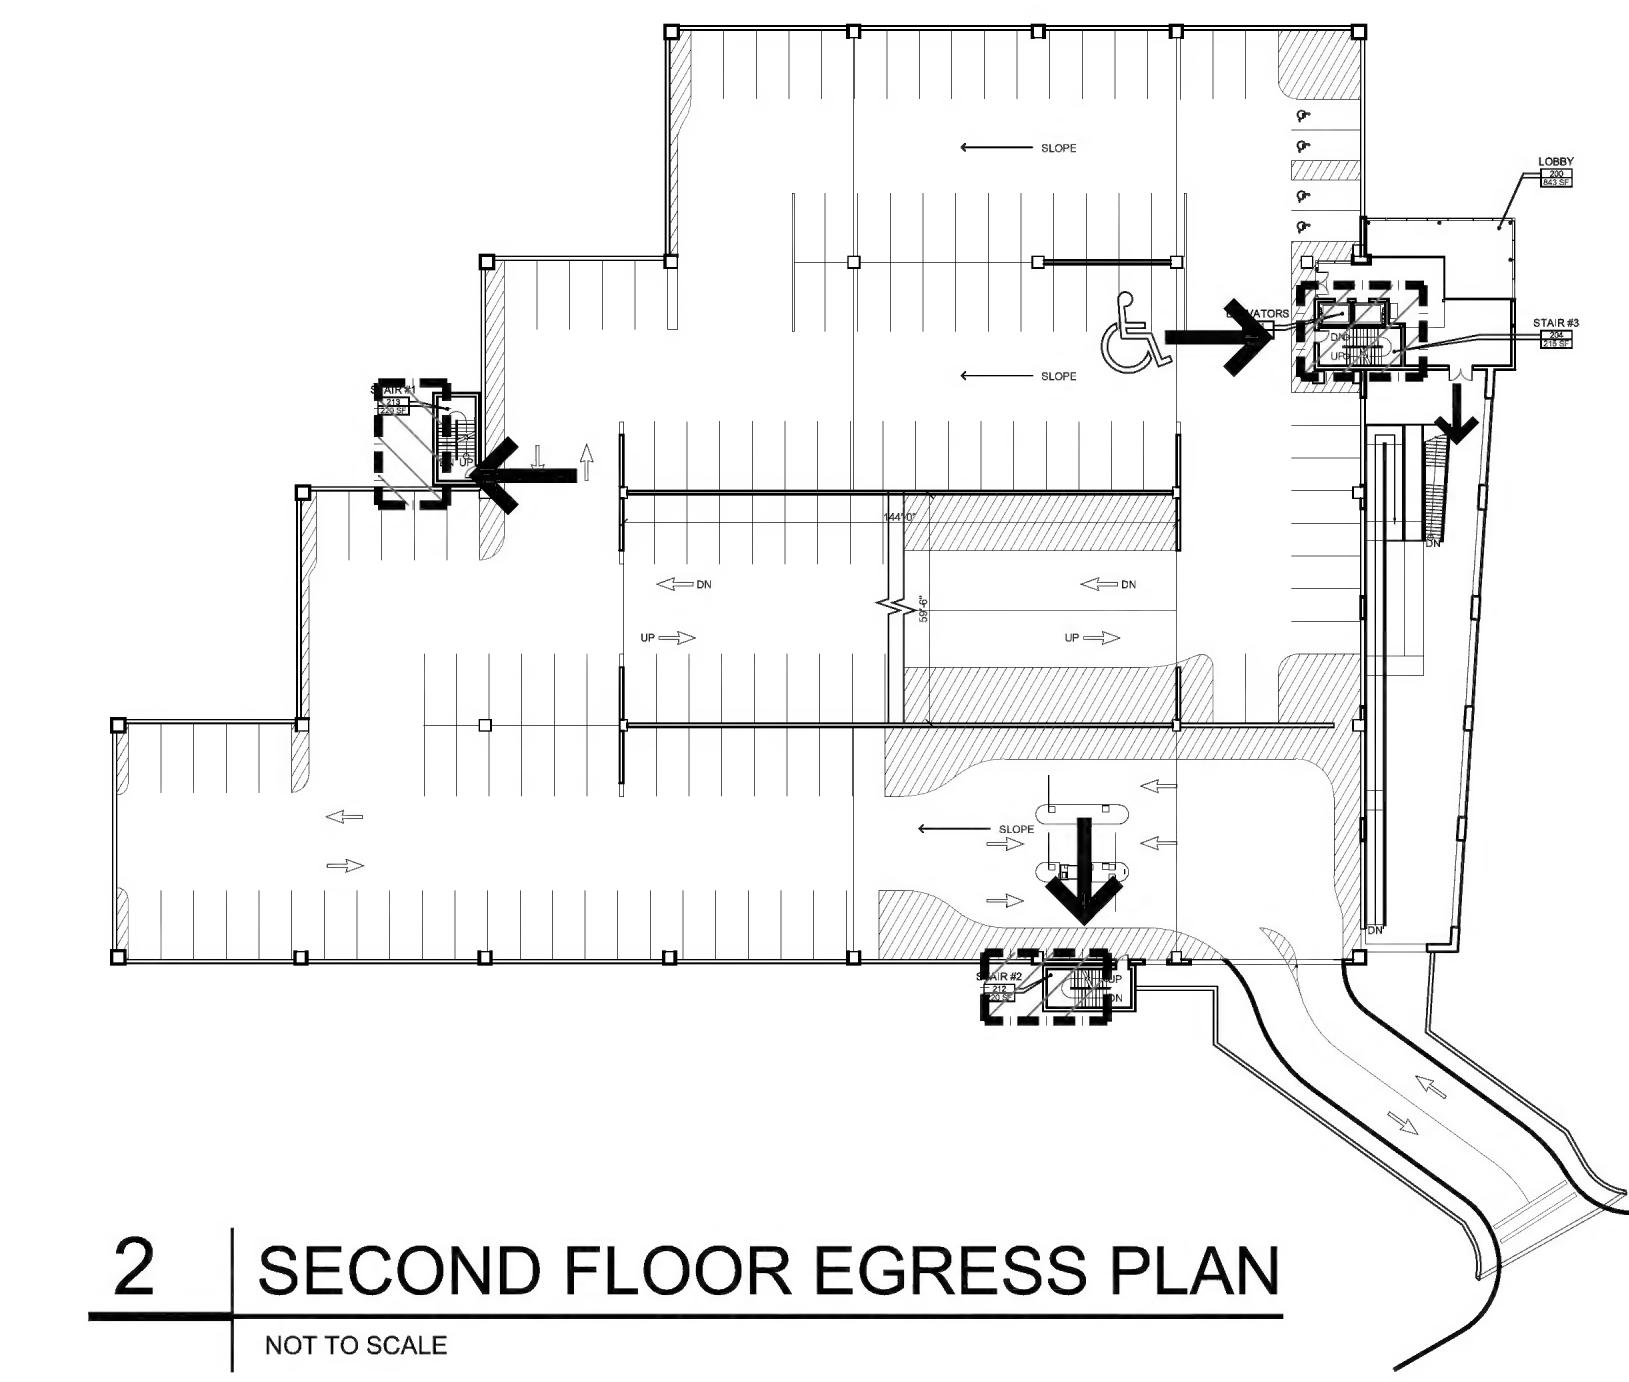


2 | SECOND FLOOR EGRESS PLAN

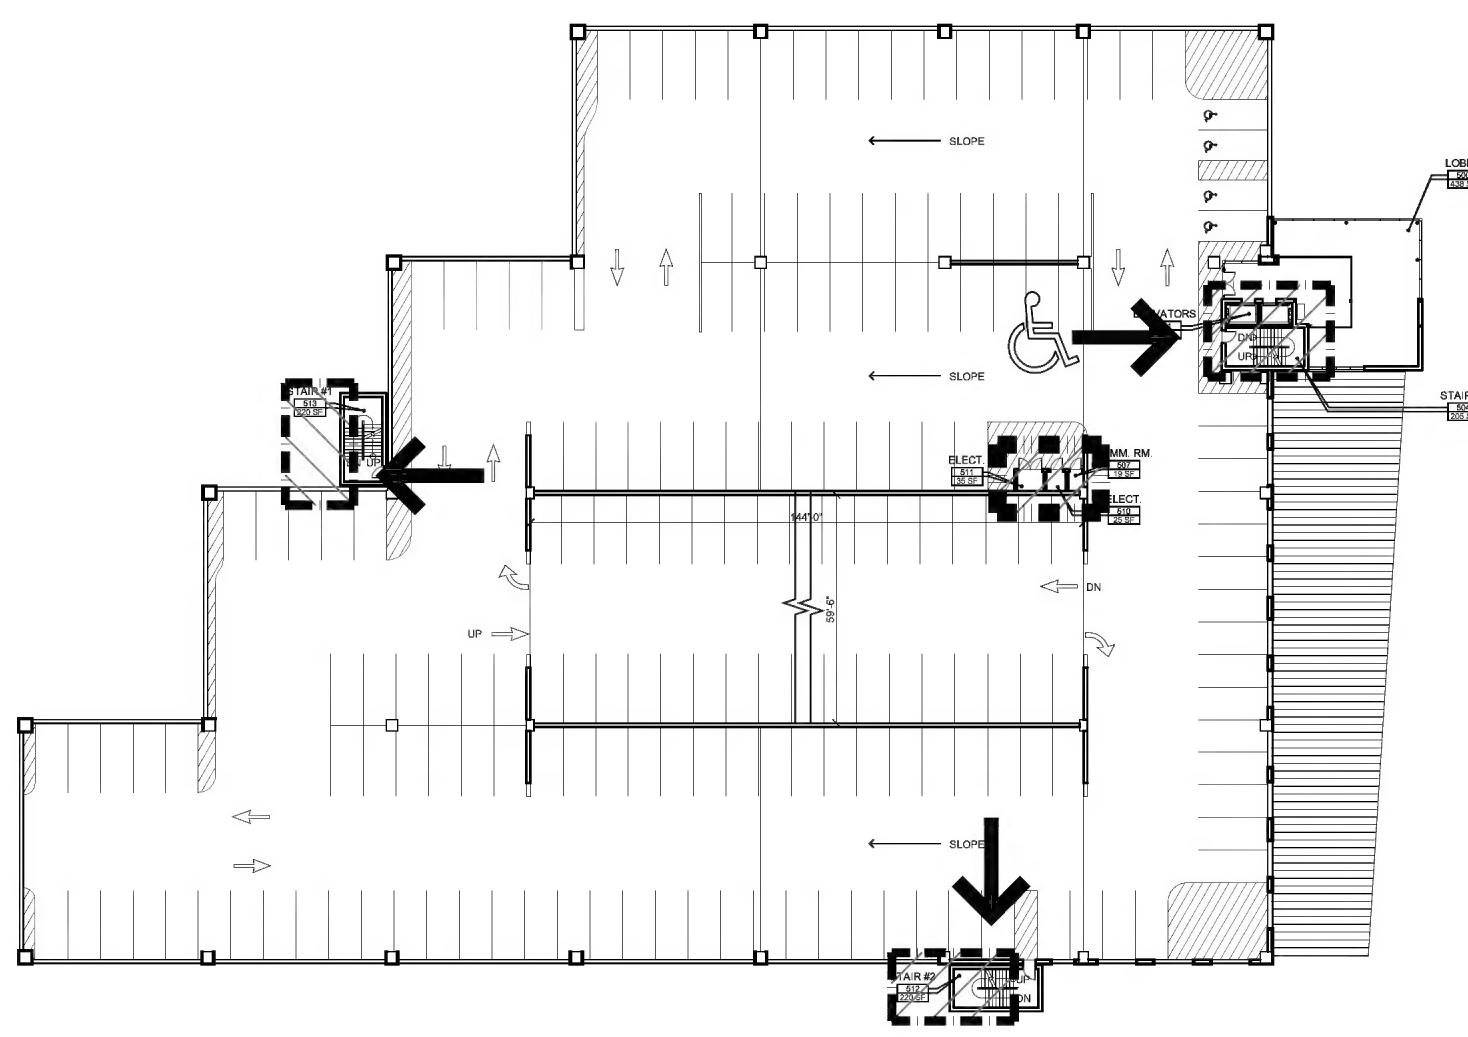


5 | FIFTH FLOOR EGRESS PLAN

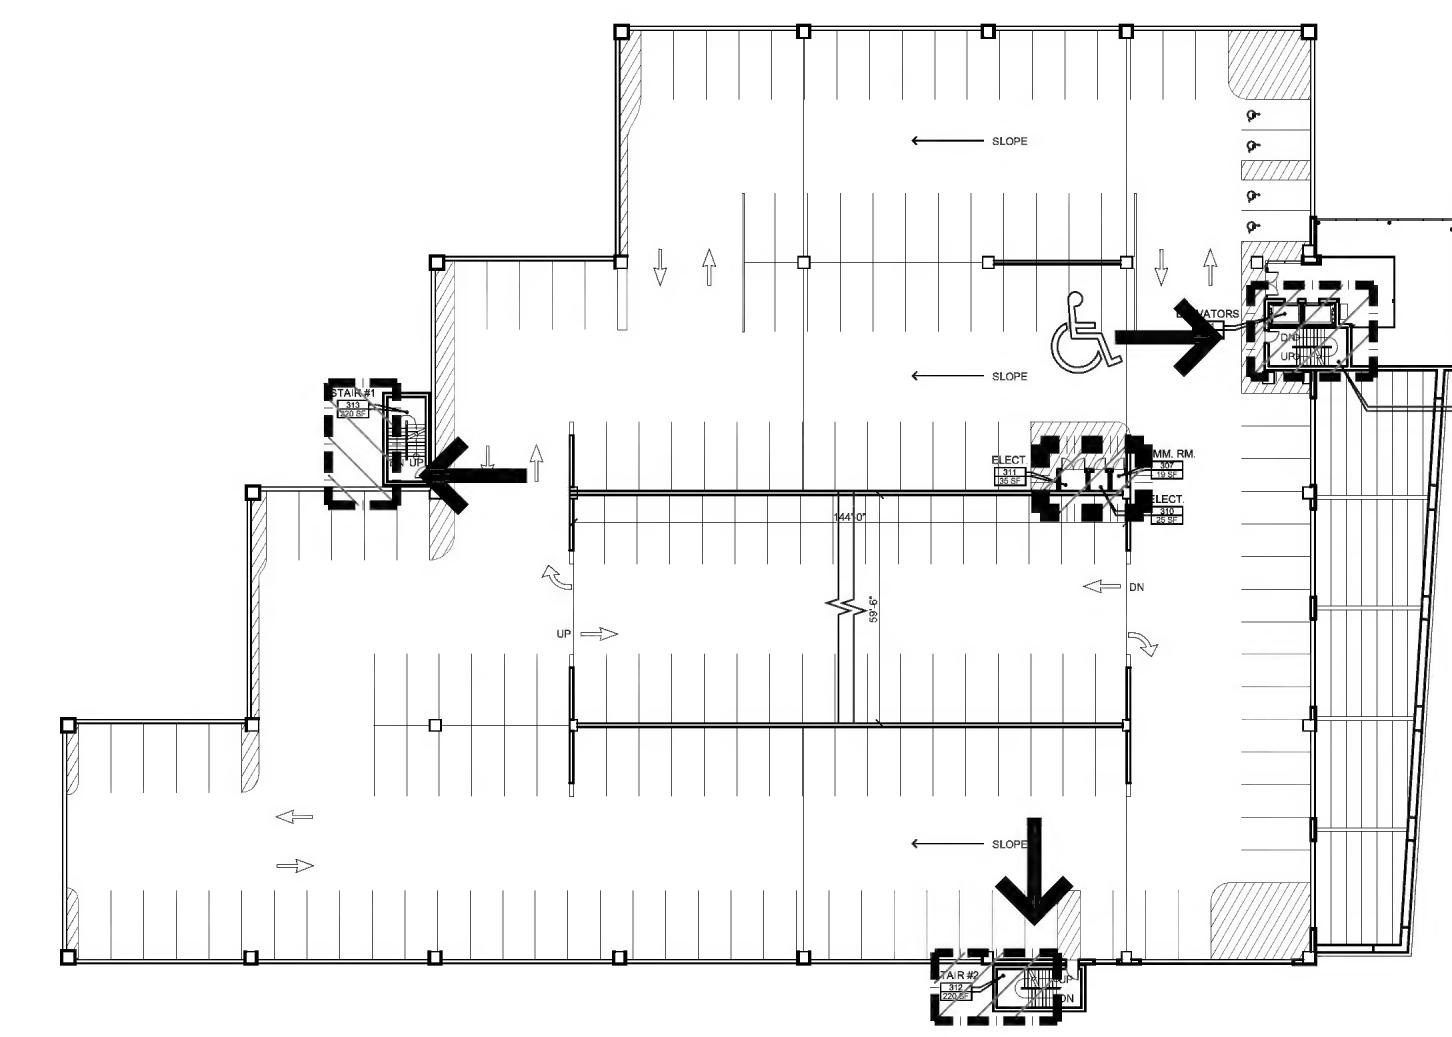

3 | THIRD FLOOR EGRESS PLAN

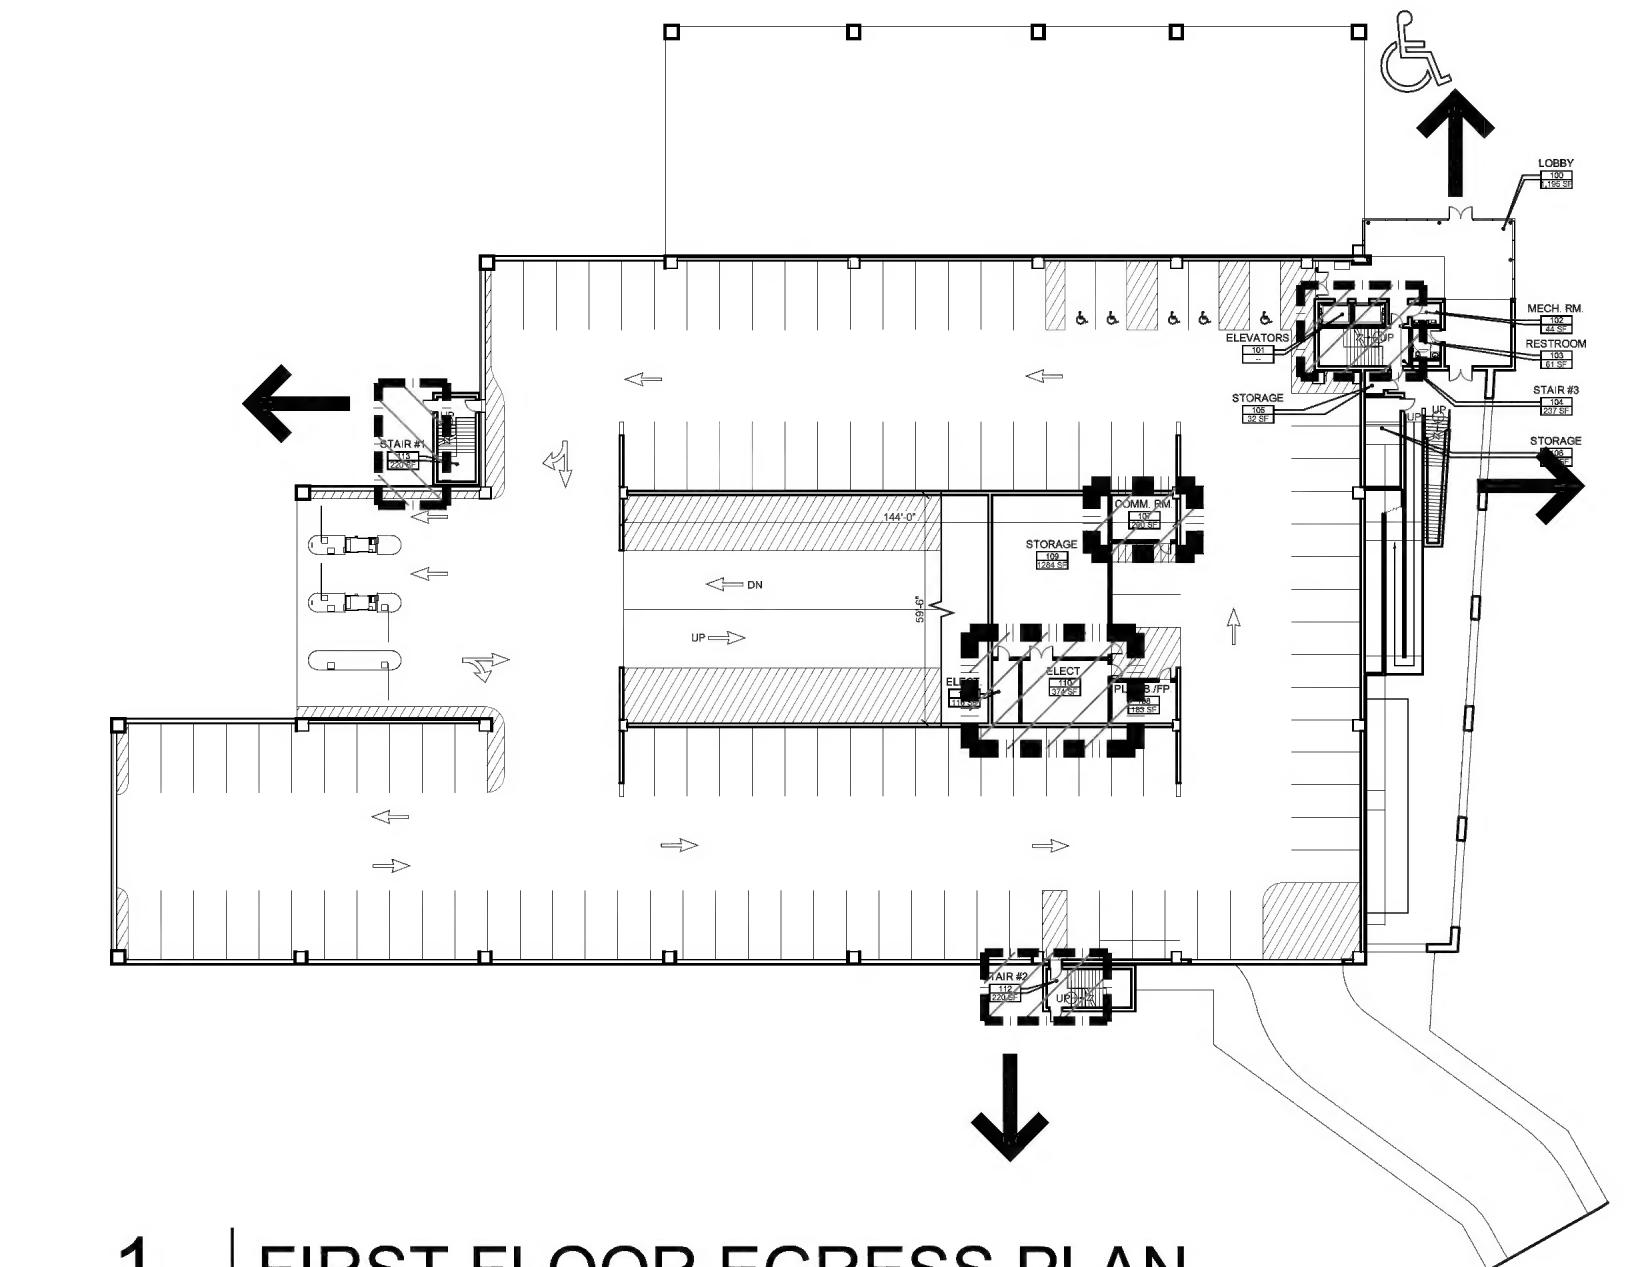

1 | FIRST FLOOR EGRESS PLAN

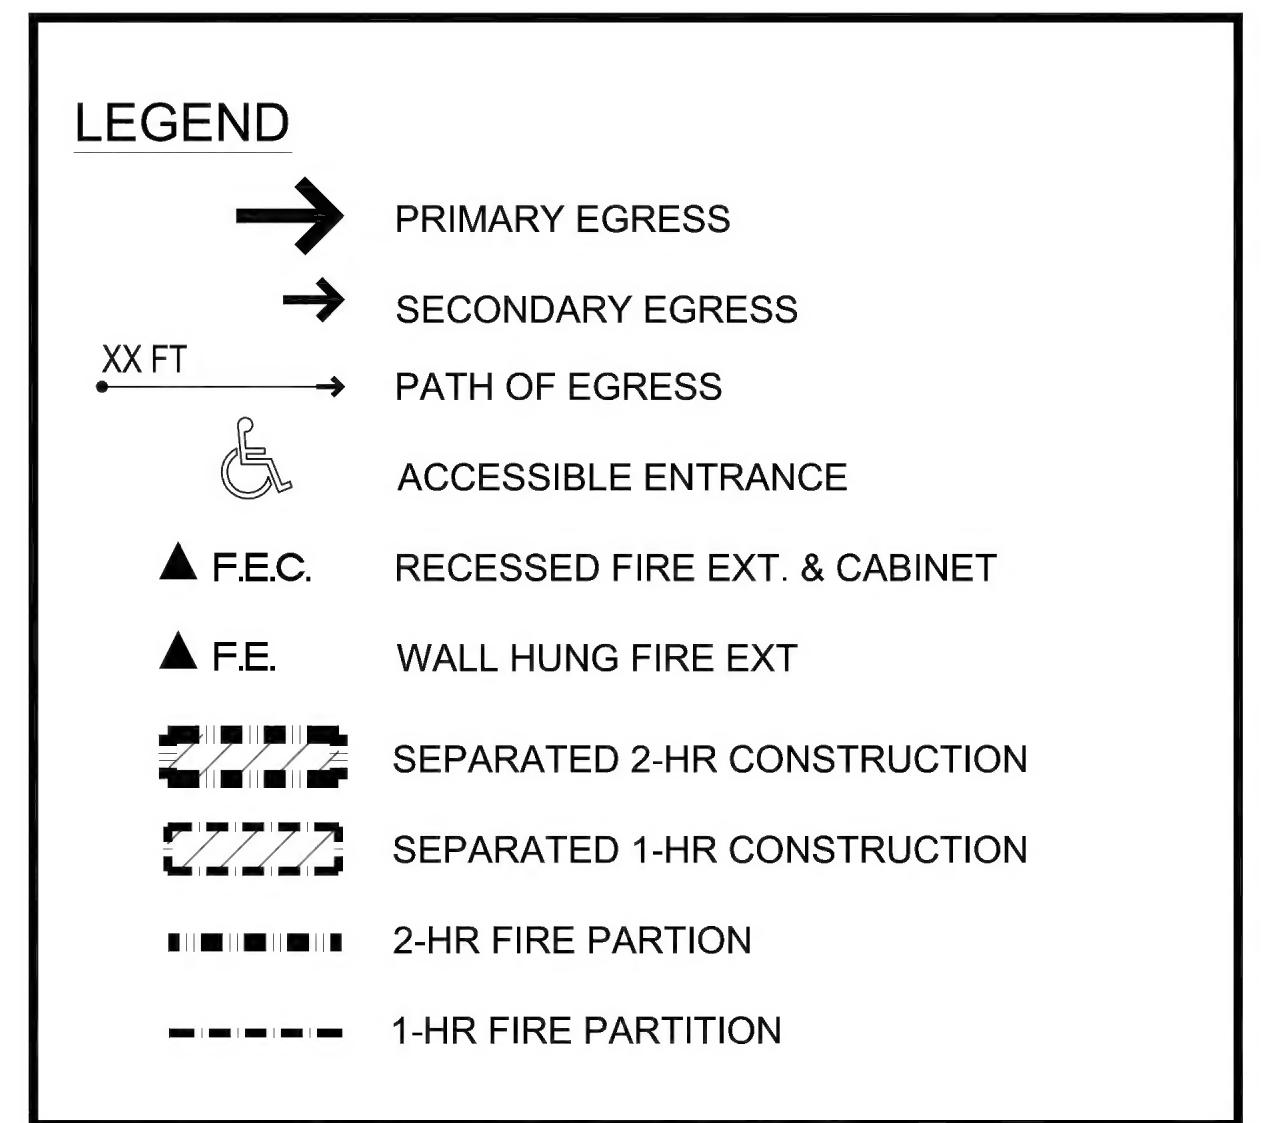

G002

## FINISH NOTES

1. FINISH GROUPS AND CEILING TYPES ARE KEYED ON PLANS.
2. CHANGE OF FLOORING MATERIAL SHALL OCCUR AT THE CENTERLINE OF DOOR IN CLOSED POSITION.
3. PROVIDE TRANSITION STRIPS BETWEEN DISSIMILAR FLOOR MATERIALS.
4. CERAMIC FLOOR TILE TO BE SLIP RESISTANT.
5. PAINT ALL RAILS, GUARDS, DOORS, FRAMES, LADDERS, BOLLARDS, AND / OR GRATINGS, INCLUDING SUCH ITEMS OCCURRING IN ROOMS NOT SCHEDULED TO RECEIVE WALL OR FLOOR FINISH.
6. PAINT ALL MECHANICAL AND ELECTRICAL EQUIPMENT, PIPING, DUCTWORK, ETC. UNLESS OTHERWISE NOTED AND / OR PRE-FINISHED BY MANUFACTURER.
7. ALL PRODUCTS AND FINISHES SHALL BE INSTALLED IN STRICT ACCORDANCE WITH, AND OVER SUBSTRATES PREPARED IN ACCORDANCE WITH, MANUFACTURERS WRITTEN INSTRUCTIONS AND PRODUCT LITERATURE. ALL INTERIOR FLOOR, WALL AND CEILING FINISHES SHALL HAVE A CLASS I (OR CLASS A) FLAME SPREAD CLASSIFICATION.

## ROOM FINISH LEGEND

C. CERAMIC TILE / CERAMIC BASE	P. PAINT
E. EPOXY PAINT	Q. QUARRY TILE
G. GLAZED CMU	U. SEALED CONCRETE
H. HARDENER / SEALER / STAIN	W. WOOD
L. LAMINATE	Y. ENTRY MAT
M. METAL PANEL	
N. NATURAL STONE	


## CEILING TYPES

ACT1 - 2' x 2' MILDEW RESISTANT ACOUSTICAL CEILING TILE  
 ES - EXPOSED STRUCTURE  
 MTL1 - 4' x 4' METAL PANEL SYSTEM

## ABBREVIATIONS


AD - AREA DRAIN	EXT - EXTERIOR	PL - PLATE
ALUM - ALUMINUM	EXP JT - EXPANSION JOINT	PLAM - PLASTIC LAMINATE
AOA - AIRSIDE OPERATIONS AREA	FE - FIRE EXTINGUISHER	PLAS - PLASTER
ARCH - ARCHITECTURAL	FEC - FIRE EXTINGUISHER CABINET	PNL - PANEL
AWI - AMERICAN WOODWORKERS INSTITUTE	FFE - FINISH FLOOR ELEVATION	PRESS - PRESSURE
B - BASELINE	FID - FLIGHT INFORMATION DISPLAY	PT - PRESSURE TREATED
BAT - BATTERY	FIN FLR - FINISHED FLOOR	PTD - PAINTED
BOT - BOTTOM	FOW - FACE OF WALL	R - RADIUS
BLDG - BUILDING	FD - FLOOR DRAIN	RAR - RETURN AIR REGISTER
BRD - BACKUP ROOF DRAIN	FT - FOOT / FEET	RCP - REFLECTED CEILING PLAN
C - CENTER LINE	GA - GAUGE	RD - ROOF DRAIN
CFMF - COLD-FORMED METAL FRAMING	GALV - GALVANIZED	REQ'S - REQUIREMENTS
CIP - CAST IN PLACE	GR - GROUND	REQ'D - REQUIRED
CLG - CEILING	GWB - GYPSUM WALL BOARD	SGFT - STRUCTURAL GLAZED FACING TILE
CLOS - CLOSET	H - HEIGHT	SPK - SPRINKLER
CLR - CLEAR	HDWD - HARDWOOD	SQ - SQUARE
CMU - CONCRETE MASONRY UNIT	HP - HIGH POINT	STL - STEEL
COL - COLUMN	HR - HOUR	STC - SOUND TRANSMISSION CO
CONC - CONCRETE	ID - INSIDE DIAMETER	STD - STANDARD
CONN - CONNECTION	INT - INTERIOR	SUSP - SUSPENDED
CONST - CONSTRUCTION	IPCS - INTEGRATED PROJECT CONTROL SYSTEM	SS - STAINLESS STEEL
CONT - CONTINUOUS	JAN - JANITOR	STRUC - STRUCTURE
CT - CERAMIC TILE	JT - JOINT	SIM - SIMILAR
DEG - DEGREE(S)	IN - INCH	SP - SPACES
DES - DESIGNATION	LAV - LAVATORY	TEL - TELEPHONE
DF - DRINKING FOUNTAIN	LCC - LEAD COATED COPPER	TH - THICKNESS
DIA - DIAMETER	LT - LIGHT	TO - TOP OF
DIM - DIMENSION	MAX - MAXIMUM	TOC - TOP OF CONCRETE
DWG(S) - DRAWING(S)	MDO - MEDIUM DENSITY OVERLAY	TOS - TOP OF STEEL
DH - DOOR HEIGHT	MECH - MECHANICAL	TRTD - TREATED
DS - DOWN SPOUT	MIN - MINIMUM	TYP - TYPICAL
DTL - DETAIL	MTL - METAL	UON - UNLESS OTHERWISE NOTED
ECB - EMERGENCY CALL BOX	NIC - NOT IN CONTRACT	UPS - UNINTERRUPTED POWER SOURCE
ELEC - ELECTRICAL	NO - NUMBER	VB - VAPOR BARRIER
EL - ELEVATION	NTS - NOT TO SCALE	VNR - VENEER
ELEV(S) - ELEVATOR(S)	OC - ON CENTER	W - WIDTH
EQ - EQUAL	OH - OPPOSITE HAND	WP - WORKPOINT
ES - EXPOSED STRUCTURE	OFOI - OWNER TO FURNISH & INSTALL	W/ - WITH
EXP - EXPANSION	PAX - PASSENGERS	
	PC - PRE-CAST	
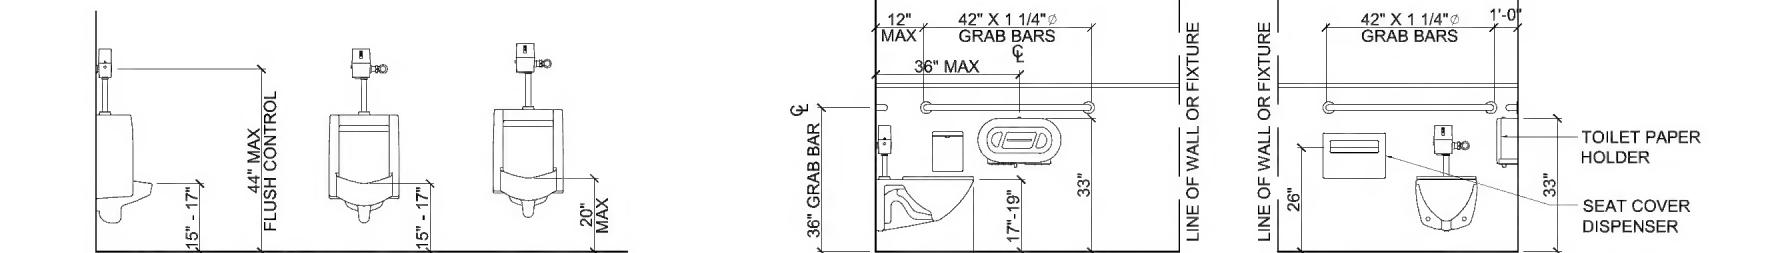
## TYPICAL MOUNTING HEIGHTS




NOTE: MAXIMUM HEIGHT SHALL BE REDUCED TO 3'-8" WHERE AN OBSTRUCTION (SHELF, TABLE) OCCURS IN FRONT OF CONTROL OR OPERATING PARTS.

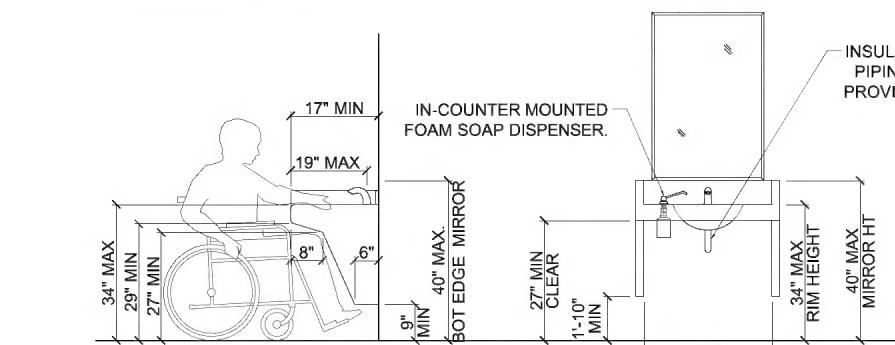MIN. MOUNTING HEIGHT: 15" AFF (ACCESSIBLE)




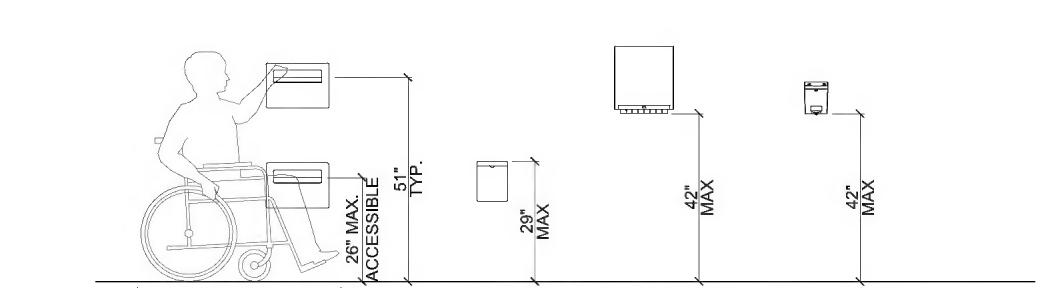1. PROVIDE WOOD BLOCKING IN WALLS TO RECEIVE ALL ACCESSORIES, MILLWORK, FASTENERS AND TOILET PARTITIONS.
2. VERIFY ALL MOUNTING HEIGHTS AND CLEARANCES WITH APPLICABLE BUILDING CODES.



1. MAXIMUM MOUNTING HEIGHTS (48" OR 54") FOR OPERATING PARTS OF MISCELLANEOUS ACCESSORIES, INCLUDING: ELECTRICAL SWITCHES AND CONTROLS.

## REFERENCE SYMBOLS

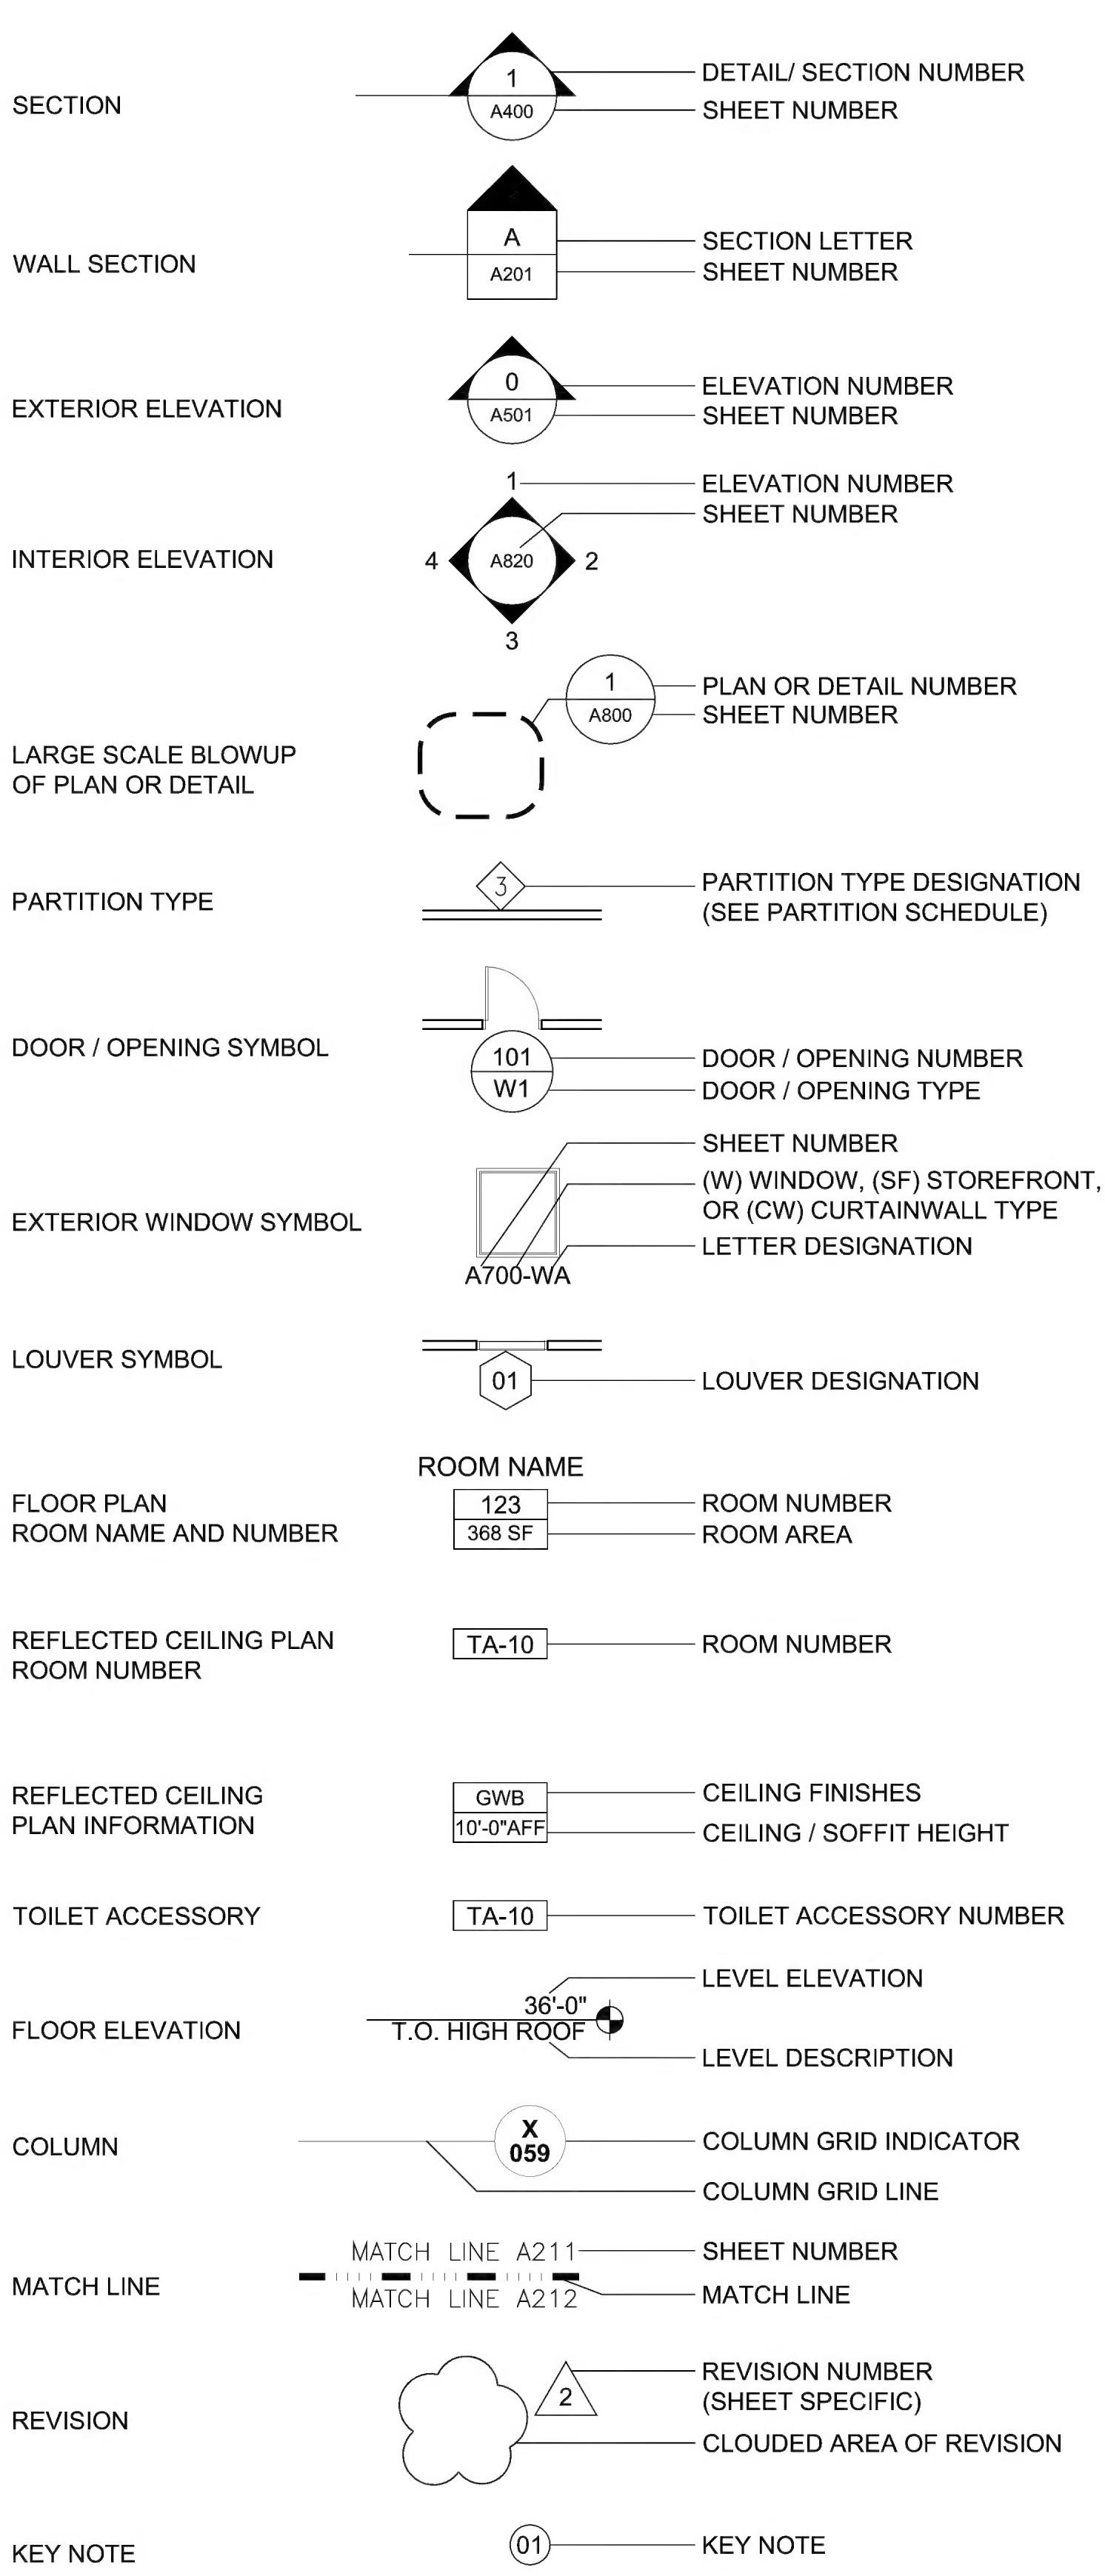

## GENERAL NOTES

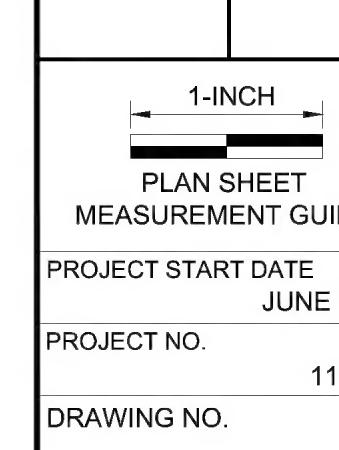
1. GENERAL NOTES ARE APPLICABLE UNLESS OTHERWISE NOTED ON THE DRAWINGS AND IN THE SPECIFICATIONS.
2. GENERAL CONTRACTOR TO VERIFY ALL DIMENSIONS SHOWN ON THE DRAWINGS AND NOTIFY THE ARCHITECT OF ANY DISCREPANCIES PRIOR TO CONSTRUCTION. DO NOT SCALE DRAWINGS.
3. REFER TO MECHANICAL, ELECTRICAL, AND STRUCTURAL DRAWINGS FOR CONCRETE PAD REQUIREMENTS.
4. APPLY DAMPROOFING AT EXTERIOR FACE OF CONCRETE FOUNDATION WALLS AT LOCATIONS WHERE FINISH FLOOR ELEVATIONS ARE BELOW EXTERIOR GRADE.
5. APPLY DAMPROOFING TO EXTERIOR FACE OF CMU INNER WYTHE (BEHIND VENEER).
6. INSTALL SEALANT AND BACKER ROD MATERIAL OVER EXPANSION JOINT MATERIAL WHERE PAVEMENT ABUTS VERTICAL SURFACES.
7. INSTALL FIRE SAFING INSULATION AND SEALANT AT RATED PARTITIONS, CEILINGS, AND FLOORS WHERE REQUIRED TO CLOSE OPENINGS, INCLUDING PERIMETER OF DUCTS, PIPES, BEAMS AND OTHER PENETRATIONS.
8. PROVIDE FLOOR, WALL, AND CEILING EXPANSION JOINT PLATES AT EXPOSED EXPANSION JOINTS.
9. PROVIDE FIRE EXTINGUISHER CABINETS WITH EXTINGUISHERS. RECESS MOUNTED ON DRAWINGS (TOP AT 60 INCHES AFF).
10. FURNISHING AND / OR EQUIPMENT SHOWN DOTTED ON PLANS ARE NOT IN CONTRACT UNLESS NOTED OTHERWISE.
11. ALL TOILET ACCESSORIES ARE SURFACE MOUNTED UNLESS OTHERWISE NOTED ON TOILET ACCESSORY SCHEDULE.
12. REFER TO PLUMBING DRAWINGS FOR ADDITIONAL FLOOR DRAIN LOCATIONS.
13. PROVIDE ACCESS DOORS IN WALLS AND CEILINGS AS REQUIRED FOR ELECTRICAL, MECHANICAL, AND / OR PLUMBING AND SIMILAR ITEMS. LOCATION OF ACCESS DOORS MUST BE CONFIRMED / COORDINATED WITH THE ARCHITECT PRIOR TO INSTALLATION.
14. PROVIDE NEW PERMANENT ADA APPROVED SIGNS (WITH APPLIED LETTERS) MOUNTED TO LATCH SIDE OF DOORS AT A HEIGHT OF 60 INCHES AFF AT ALL RESTROOM(S), JANITOR'S CLOSETS, ELECTRICAL ROOMS, MECHANICAL ROOMS, AND SIMILAR AREAS. REFER TO SIGNAGE DRAWINGS.

**AECOM**

38 CHAUNCEY STREET  
TENTH FLOOR SUITE 1001  
BOSTON, MASSACHUSETTS 02111  
617-482-4835

MASSACHUSETTS BAY TRANSPORTATION AUTHORITY  
SALEM COMMUTER RAIL STATION INTERMODAL CENTER  
SALEM, MASSACHUSETTS


GENERAL NOTES AND ABBREVIATIONS



G003

PARTITION NOTES

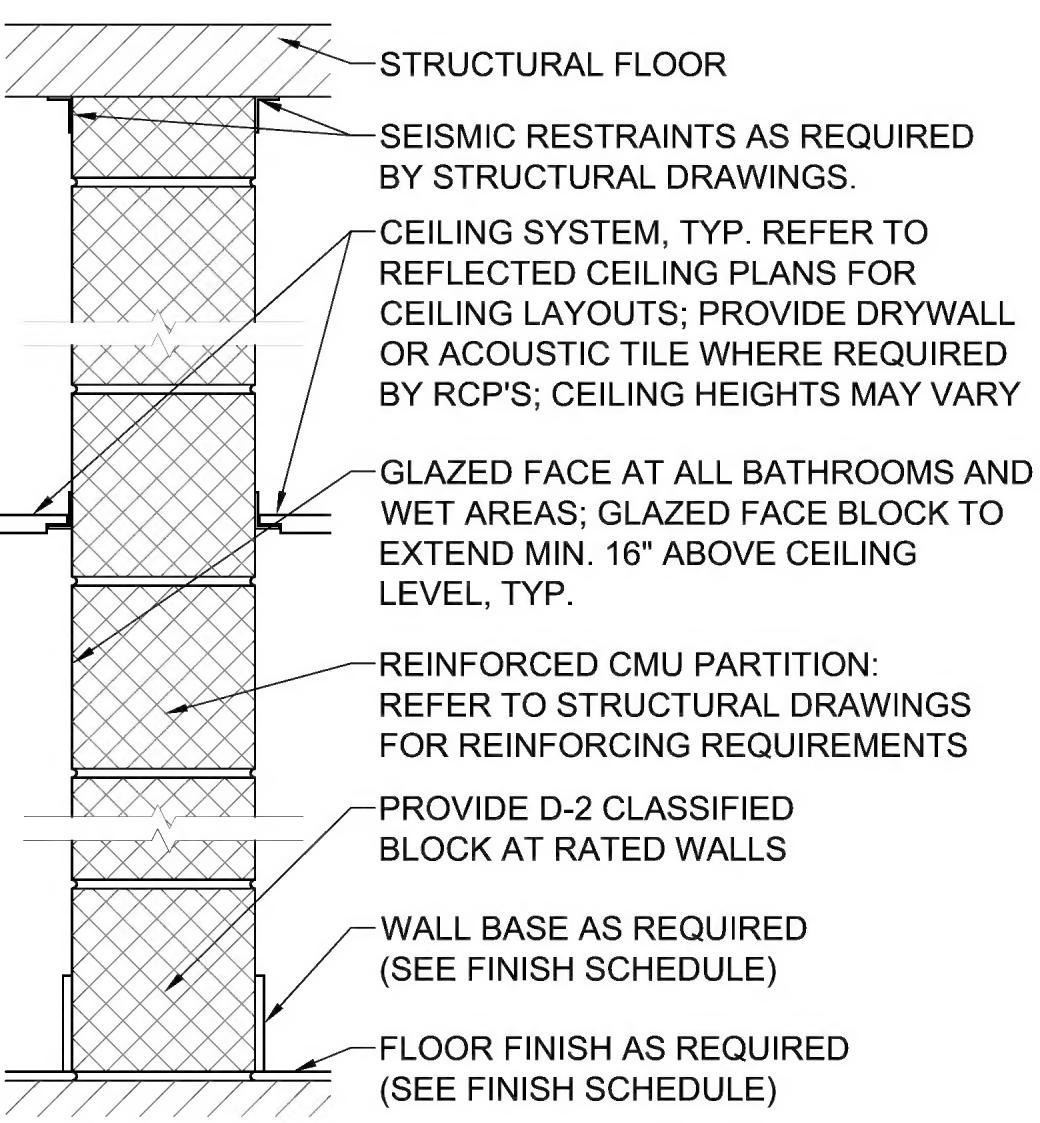1. DIMENSIONS ARE TAKEN TO AND/OR FROM FACE OF PARTITIONS UNLESS OTHERWISE NOTED OR INDICATED BY CENTERLINES.
2. EXTEND PARTITION ASSEMBLIES TO UNDERSIDE OF DECK / STRUCTURE / SLAB ABOVE UNLESS OTHERWISE NOTED. LOCATIONS OF CHASES TO BE APPROVED BY THE ARCHITECT.
3. PORTIONS OF THE PARTITIONS ABOVE AND / OR BELOW OPENINGS SHALL BE OF THE SAME PARTITION TYPE AS THE PARTITION ADJACENT TO THE OPENING.
4. REFER TO FINISH SCHEDULE FOR FINISHED APPLIED TO THE PARTITION ASSEMBLIES.
5. REFER TO THE UL FIRE RESISTANCE DIRECTORY 2000 FOR FULL DESCRIPTIONS OF FIRE RATED PARTITION ASSEMBLIES.
6. CONCEAL MECHANICAL PIPING AND / OR ELECTRICAL CONDUIT FROM FINISHED SPACES. CHASES TO BE SIZED TIGHT TO PIPING TO YIELD MINIMAL ENCROACHMENT INTO SPACE UNLESS OTHERWISE NOTED. LOCATIONS OF CHASES TO BE APPROVED BY THE ARCHITECT.
7. WRAP RECESSED CABINETS AND EQUIPMENT OCCURRING IN RATED PARTITIONS WITH CONSTRUCTION EQUIVALENT TO RATING OF PARTITIONS IN WHICH THEY OCCUR.
8. CONCRETE MASONRY UNITS (CMU) SHALL CONFORM TO FIRE RATINGS ESTABLISHED BY STANDARDS RECOGNIZED BY THE MASSACHUSETTS STATE BUILDING CODE OR EQUIVALENCY THERE TO AS ESTABLISHED BY THE EQUIVALENT THICKNESS METHOD OF THE AMERICAN INSURANCE ASSOCIATION AND SHALL COMPLY WITH UNDERWRITERS LABORATORY, INC.
9. PROVIDE MORTAR FREE JOINT AND INSTALL FIRE SAFING INSULATION BETWEEN TOP OF FIRE RATED MASONRY PARTITIONS AND UNDERSIDE OF STRUCTURE AND COMPRESSIBLE FILLER BETWEEN TOP OF NON-RATED MASONRY PARTITIONS.
10. PROVIDE CONTROL JOINTS IN MASONRY AT INTERIOR CORNERS AND AT 25 FEET ON CENTER MAXIMUM.
11. REFER TO STRUCTURAL DRAWINGS AND SPECIFICATIONS FOR ADDITIONAL MASONRY REINFORCEMENT REQUIREMENTS.
12. PROVIDE ACOUSTICAL SEALANT AT ALL SOUND RATED PARTITIONS (TOP AND BOTTOM OF PARTITION AND AT ALL PENETRATIONS) TO ACHIEVE STC RATING INDICATED.




A CMU - 8" UNRATED

A1 CMU - 8" 1HR RATED


A2 CMU - 8" 2HR RATED

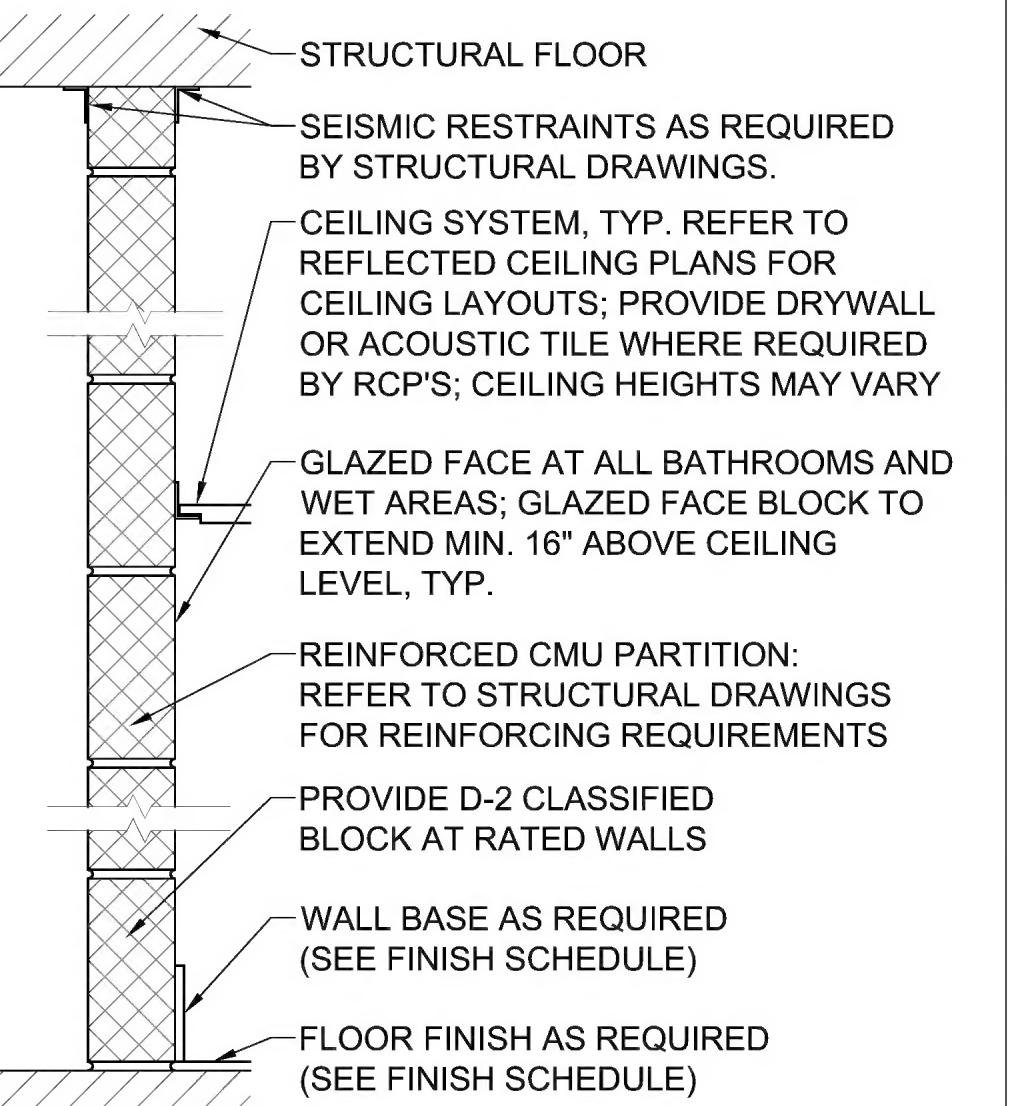03 CMU - STANDARD WALL



B CMU - 4" UNRATED

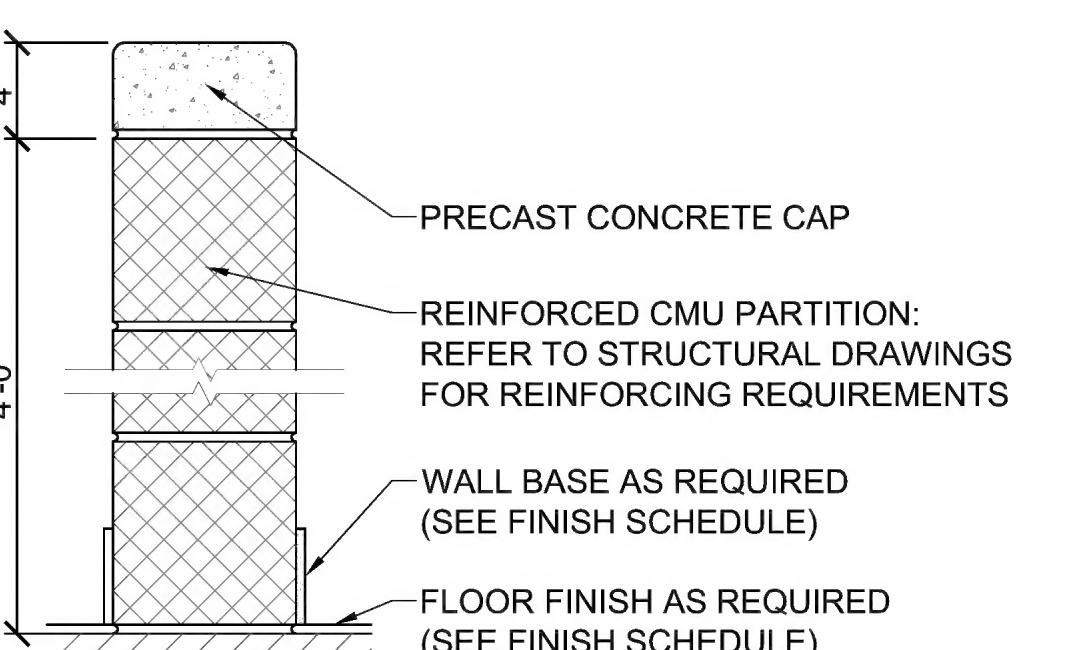02 CMU - FALSE WALL




C CMU - 8" UNRATED

01 CMU - HALF HIGH WALL


1	30% DESIGN SUBMISSION	1	30% DESIGN SUBMISSION
CONSULTANT:	CONSULTANT:	CONSULTANT:	CONSULTANT:
STAMP:	STAMP:	STAMP:	STAMP:
AECOM	AECOM	AECOM	AECOM
38 CHAUNCEY STREET TENTH FLOOR SUITE 1001 BOSTON, MASSACHUSETTS 02111 617.482.4835	38 CHAUNCEY STREET TENTH FLOOR SUITE 1001 BOSTON, MASSACHUSETTS 02111 617.482.4835	38 CHAUNCEY STREET TENTH FLOOR SUITE 1001 BOSTON, MASSACHUSETTS 02111 617.482.4835	38 CHAUNCEY STREET TENTH FLOOR SUITE 1001 BOSTON, MASSACHUSETTS 02111 617.482.4835
PARTITION TYPES	PARTITION TYPES	PARTITION TYPES	PARTITION TYPES
MASSACHUSETTS BAY TRANSPORTATION AUTHORITY SALEM COMMUTER RAIL STATION INTERMODAL CENTER SALEM, MASSACHUSETTS	MASSACHUSETTS BAY TRANSPORTATION AUTHORITY SALEM COMMUTER RAIL STATION INTERMODAL CENTER SALEM, MASSACHUSETTS	MASSACHUSETTS BAY TRANSPORTATION AUTHORITY SALEM COMMUTER RAIL STATION INTERMODAL CENTER SALEM, MASSACHUSETTS	MASSACHUSETTS BAY TRANSPORTATION AUTHORITY SALEM COMMUTER RAIL STATION INTERMODAL CENTER SALEM, MASSACHUSETTS
1-INCH PLAN SHEET MEASUREMENT GUIDE	1-INCH PLAN SHEET MEASUREMENT GUIDE	1-INCH PLAN SHEET MEASUREMENT GUIDE	1-INCH PLAN SHEET MEASUREMENT GUIDE
PROJECT START DATE JUNE 2009			
PROJECT NO. 113157	PROJECT NO. 113157	PROJECT NO. 113157	PROJECT NO. 113157
DRAWING NO. 113157	DRAWING NO. 113157	DRAWING NO. 113157	DRAWING NO. 113157


G004


<p><b>CONSTRUCTION KEYNOTES:</b></p> <ol style="list-style-type: none"> <li>ELECTRICAL TRANSFORMER, REFER TO ELECTRICAL DOCUMENTS FOR MORE INFORMATION.</li> <li>GENERATOR, REFER TO MEP&amp;FP DOCUMENTS FOR MORE INFORMATION.</li> <li>EXISTING RAILROAD TOWER BUILDING TO REMAIN AND/OR RENOVATED.</li> <li>EDGE OF RAILROAD HIGH PLATFORM.</li> <li>VEHICLE AND PEDESTRIAN CONNECTION BRIDGE TO BRIDGE AND WASHINGTON STREETS.</li> <li>CONCRETE SIDEWALK.</li> <li>PAINTED LINES INDICATING PEDESTRIAN CROSS WALK.</li> <li>DASHED LINES INDICATE PARKING STRUCTURE ABOVE.</li> <li>PAINTED STRIPING AT TAXI LANE.</li> <li>INES OF EXISTING EASEMENT.</li> <li>VEHICLE ENTRANCE TO PARKING STRUCTURE.</li> <li>BUS LANE, INCLUDING BUS STOPS.</li> <li>PLATFORM CANOPY.</li> </ol>	<p><b>GENERAL NOTES:</b></p> <ol style="list-style-type: none"> <li>REFER TO G003 FOR GENERAL NOTES.</li> <li>REFER TO G003 FOR REFERENCE SYMBOLS AND TAGS.</li> <li>REFER TO FLOOR PLANS (A200'S) FOR ADDITIONAL PLAN INFORMATION.</li> <li>REFER TO A400'S FOR EXTERIOR ELEVATIONS.</li> <li>REFER TO A500'S FOR BUILDING SECTIONS.</li> <li>REFER TO STRUCTURAL DOCUMENTS FOR ADDITIONAL INFORMATION.</li> <li>REFER TO CIVIL DOCUMENTS FOR ADDITIONAL SITE PLAN INFORMATION.</li> </ol>	<p><b>LEGEND:</b></p> <table border="1"> <tr> <td>■</td> <td>EXISTING BUILDINGS</td> </tr> <tr> <td>—</td> <td>EDGE OF NORTH RIVER WATER LINE</td> </tr> <tr> <td>—</td> <td>LINES INDICATE RAILROAD TRACKS</td> </tr> </table>	■	EXISTING BUILDINGS	—	EDGE OF NORTH RIVER WATER LINE	—	LINES INDICATE RAILROAD TRACKS
■	EXISTING BUILDINGS							
—	EDGE OF NORTH RIVER WATER LINE							
—	LINES INDICATE RAILROAD TRACKS							

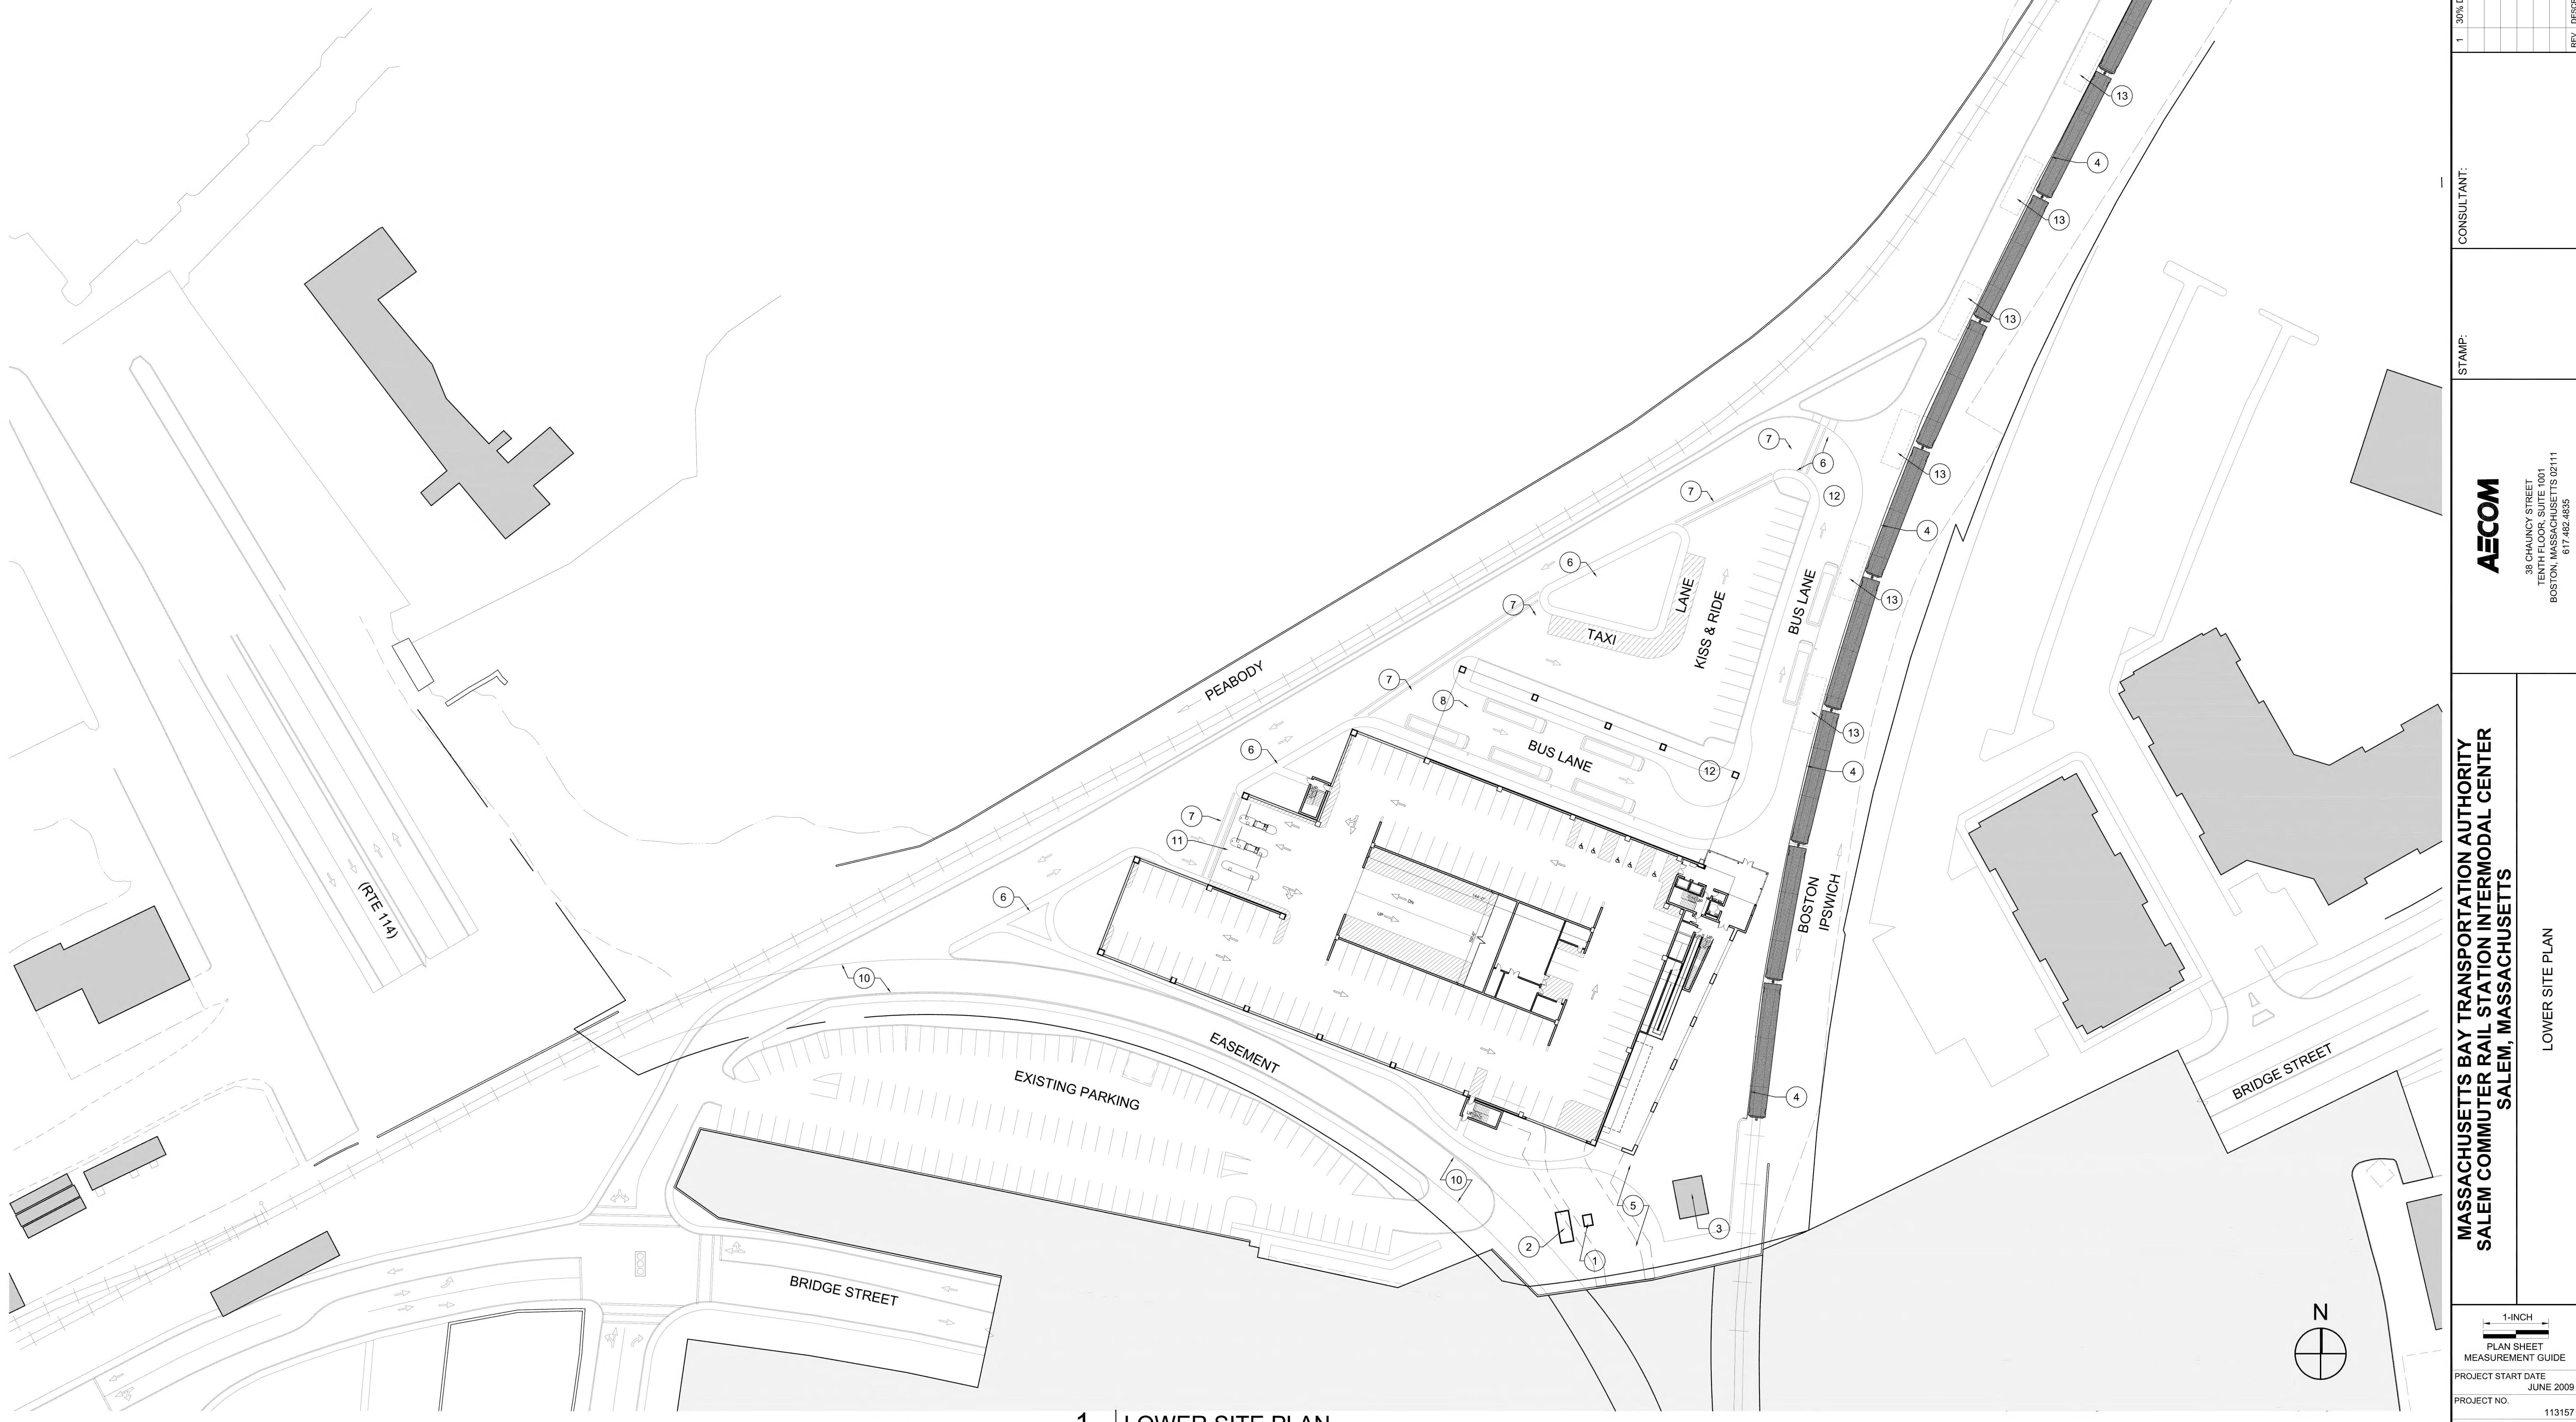

<p><b>CONSTRUCTION KEYNOTES:</b></p> <ol style="list-style-type: none"> <li>ELECTRICAL TRANSFORMER, REFER TO ELECTRICAL DOCUMENTS FOR MORE INFORMATION.</li> <li>GENERATOR, REFER TO MEP&amp;FP DOCUMENTS FOR MORE INFORMATION.</li> <li>EXISTING RAILROAD TOWER BUILDING TO REMAIN AND/OR RENOVATED.</li> <li>EDGE OF RAILROAD HIGH PLATFORM.</li> <li>VEHICLE AND PEDESTRIAN CONNECTION BRIDGE TO BRIDGE AND WASHINGTON STREETS.</li> <li>CONCRETE SIDEWALK.</li> <li>PAINTED LINES INDICATING PEDESTRIAN CROSS WALK.</li> <li>DASHED LINES INDICATE PARKING STRUCTURE ABOVE.</li> <li>PAINTED STRIPING AT TAXI LANE.</li> <li>INES OF EXISTING EASEMENT.</li> <li>VEHICLE ENTRANCE TO PARKING STRUCTURE.</li> <li>BUS LANE, INCLUDING BUS STOPS.</li> <li>PLATFORM CANOPY.</li> </ol>	<p><b>GENERAL NOTES:</b></p> <ol style="list-style-type: none"> <li>REFER TO G003 FOR GENERAL NOTES.</li> <li>REFER TO G003 FOR REFERENCE SYMBOLS AND TAGS.</li> <li>REFER TO FLOOR PLANS (A200'S) FOR ADDITIONAL PLAN INFORMATION.</li> <li>REFER TO A400'S FOR EXTERIOR ELEVATIONS.</li> <li>REFER TO A500'S FOR BUILDING SECTIONS.</li> <li>REFER TO STRUCTURAL DOCUMENTS FOR ADDITIONAL INFORMATION.</li> <li>REFER TO CIVIL DOCUMENTS FOR ADDITIONAL SITE PLAN INFORMATION.</li> </ol>	<p><b>LEGEND:</b></p> <table border="1"> <tr> <td>EXISTING BUILDINGS</td> </tr> <tr> <td>EDGE OF NORTH RIVER WATER LINE</td> </tr> <tr> <td>LINES INDICATE RAILROAD TRACKS</td> </tr> </table>	EXISTING BUILDINGS	EDGE OF NORTH RIVER WATER LINE	LINES INDICATE RAILROAD TRACKS
EXISTING BUILDINGS					
EDGE OF NORTH RIVER WATER LINE					
LINES INDICATE RAILROAD TRACKS					

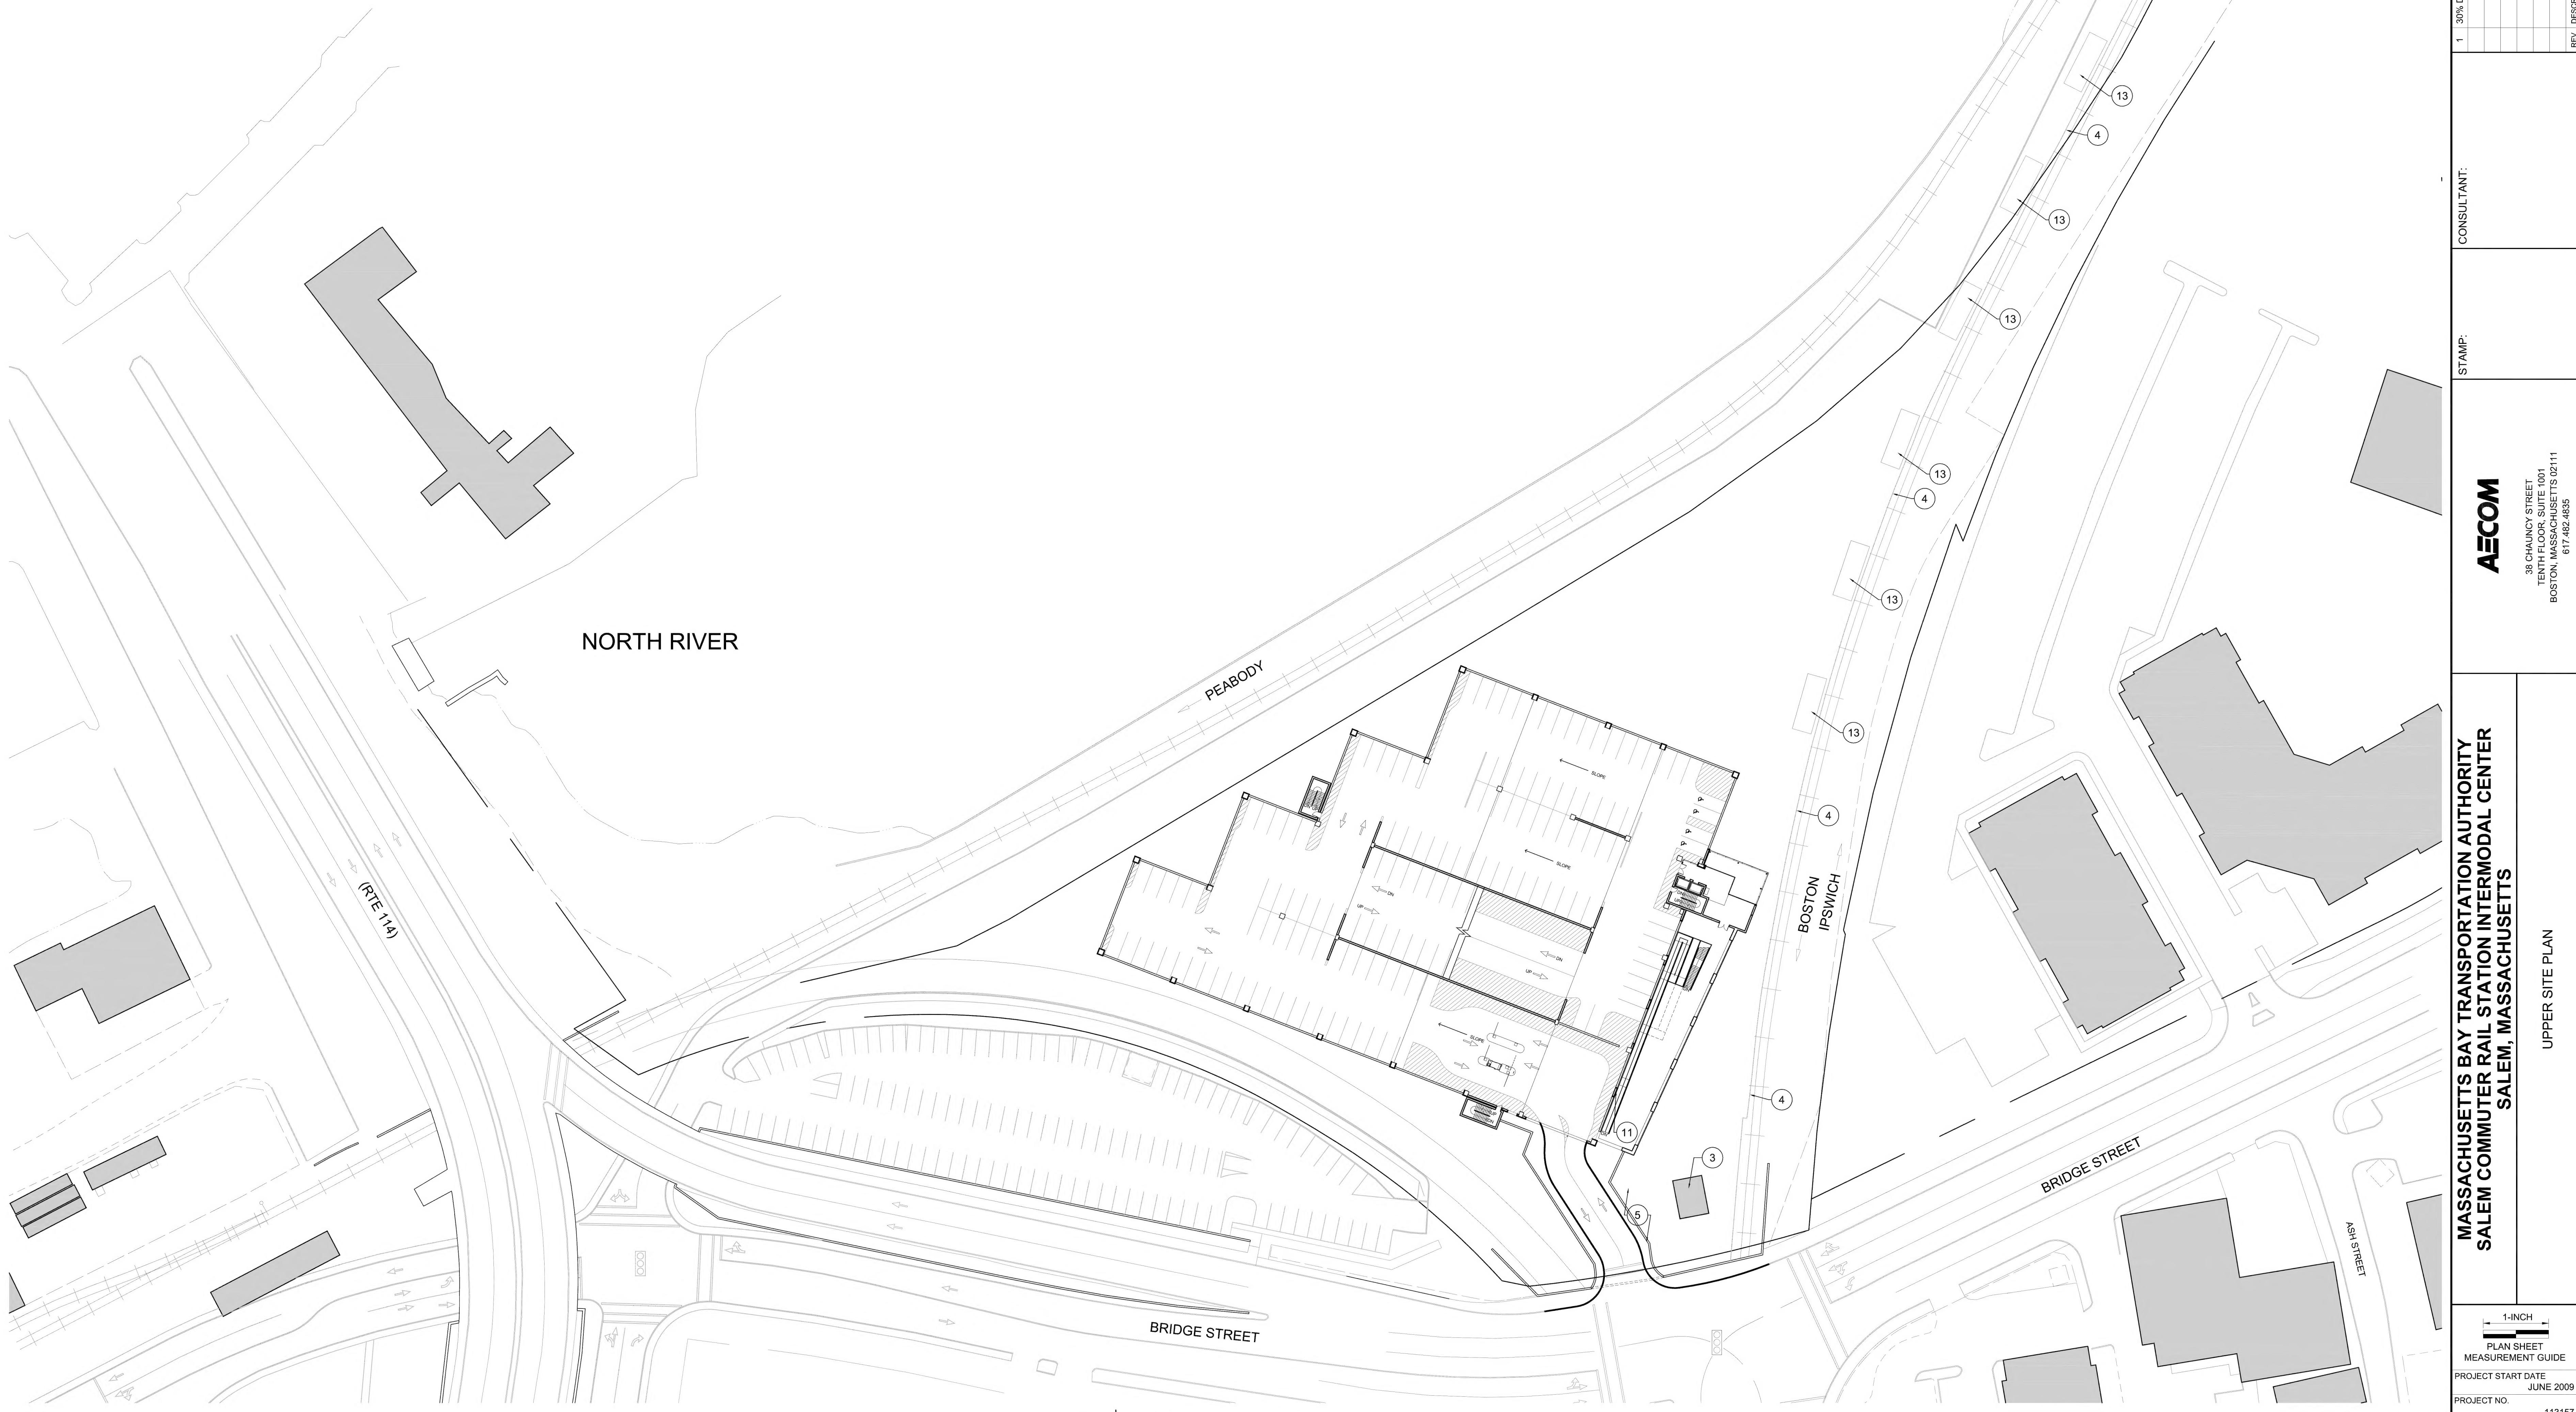

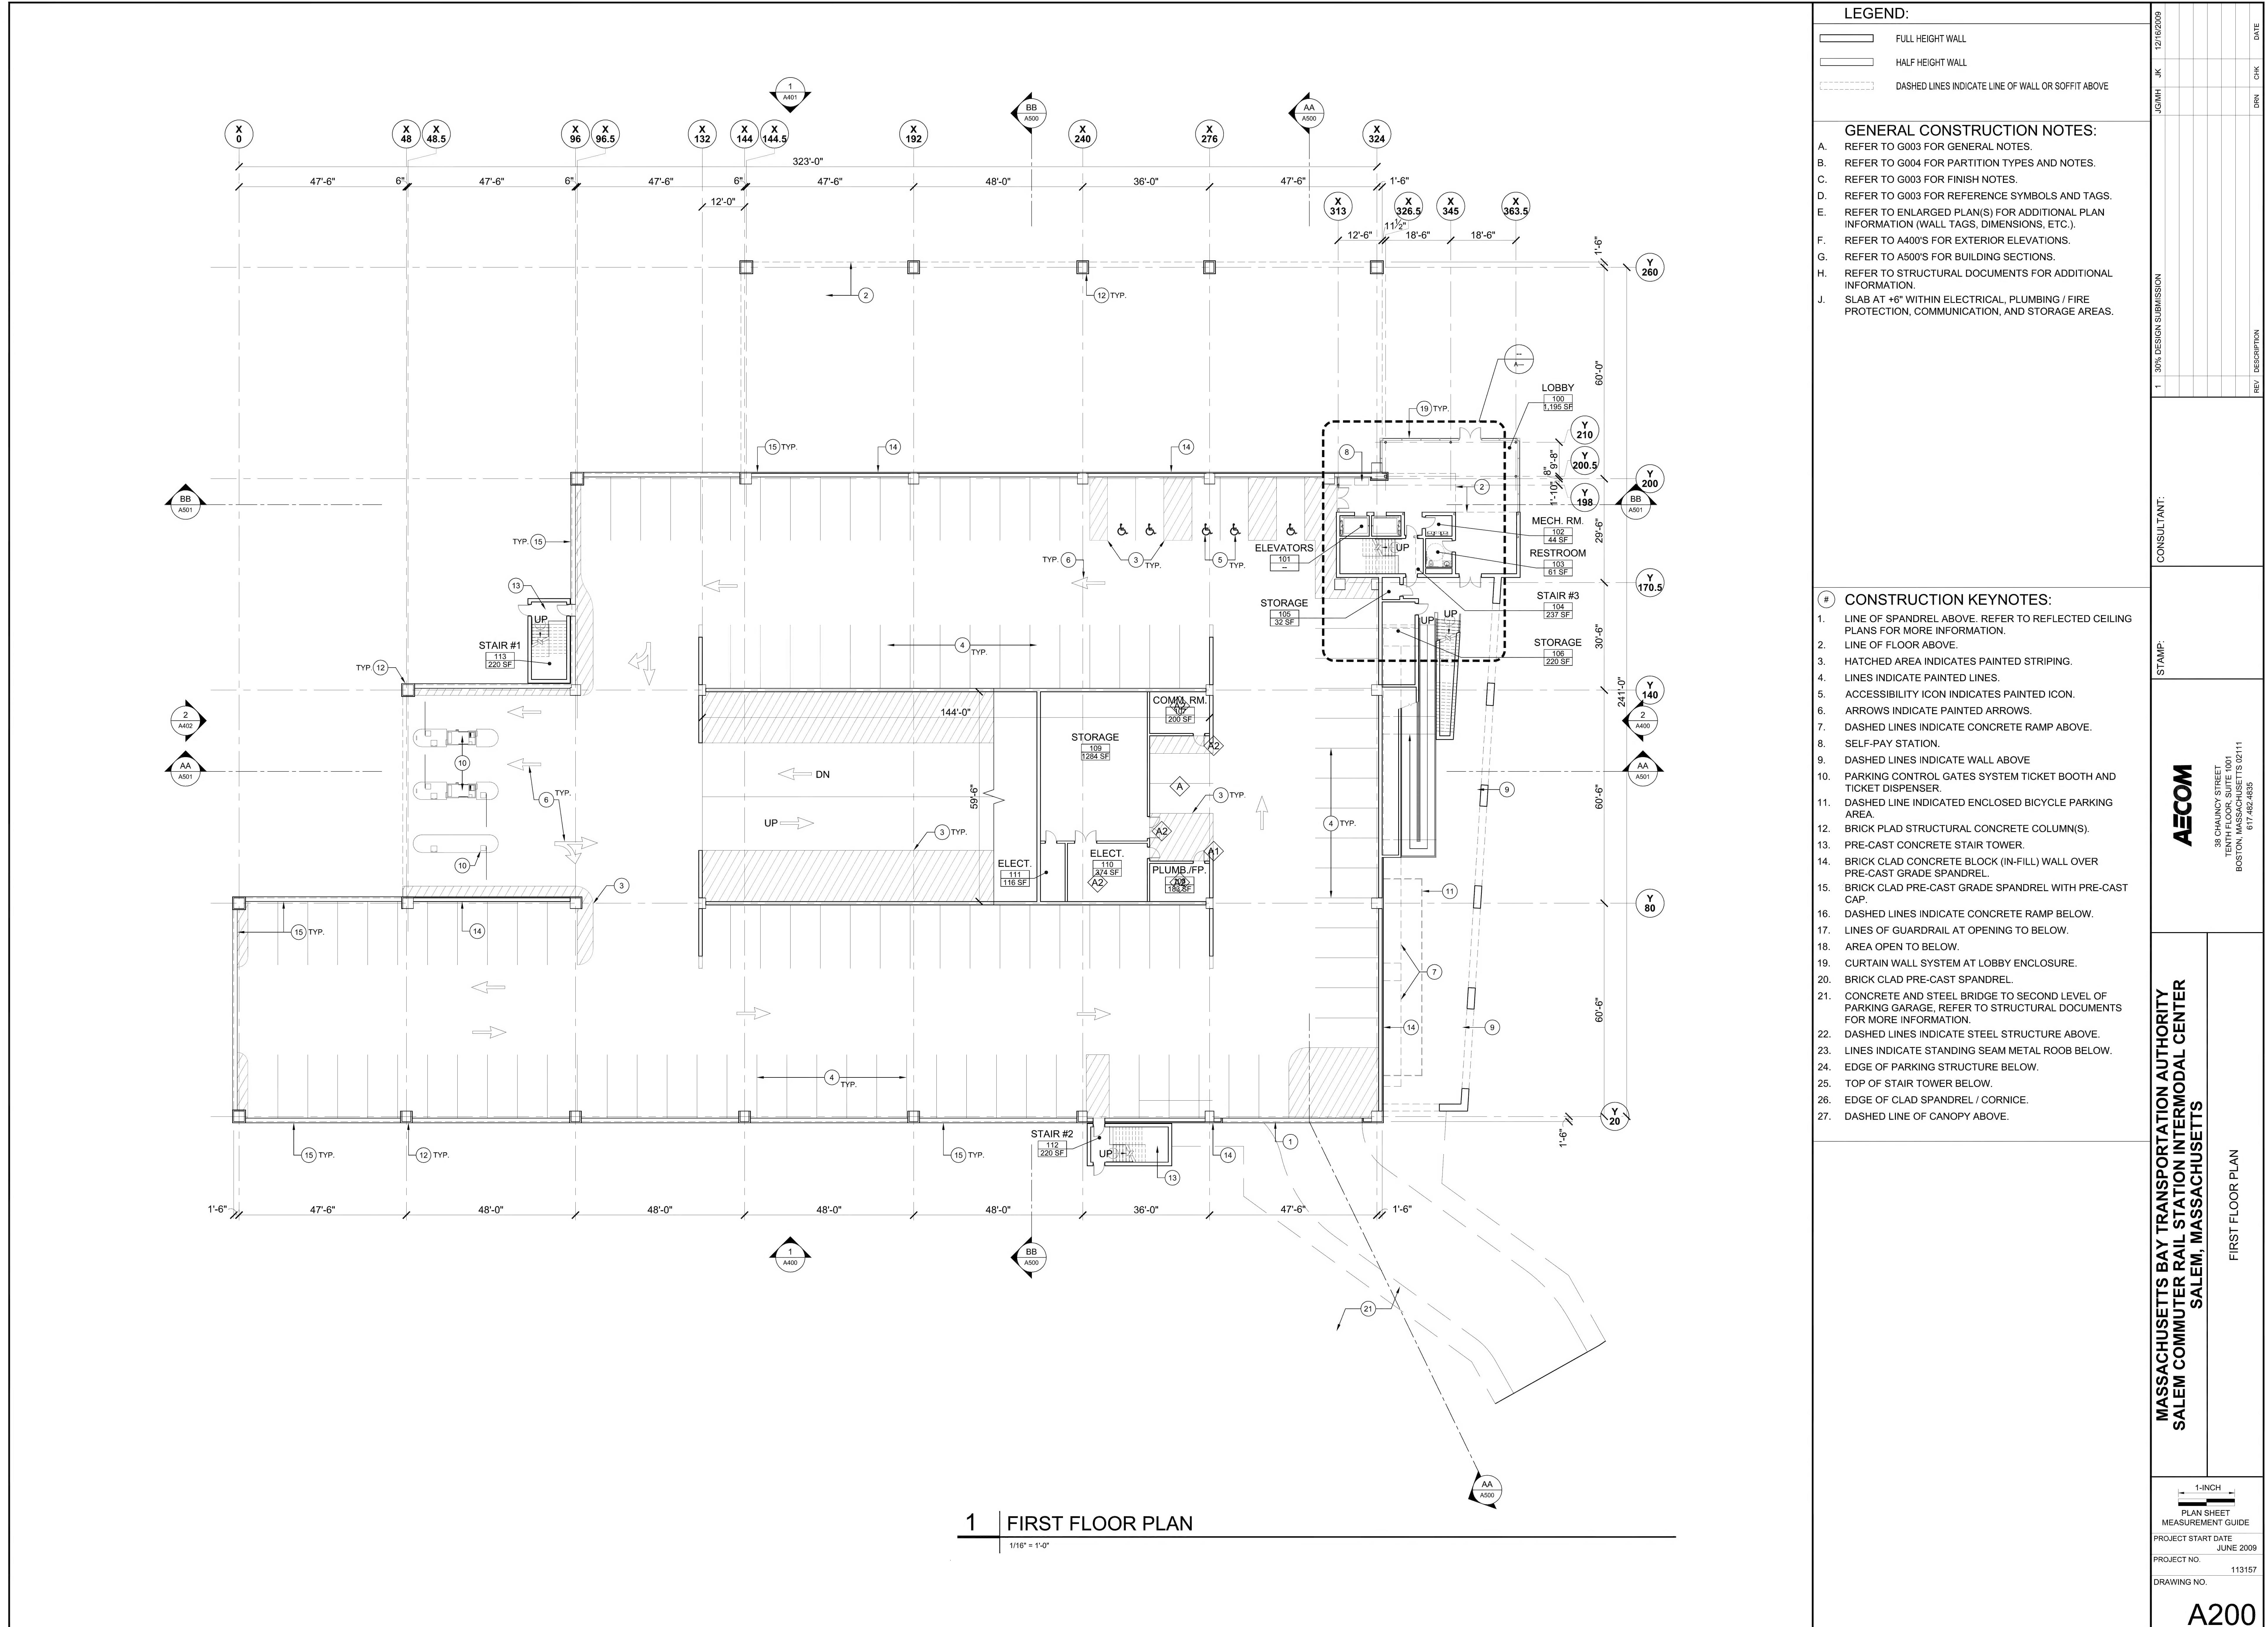

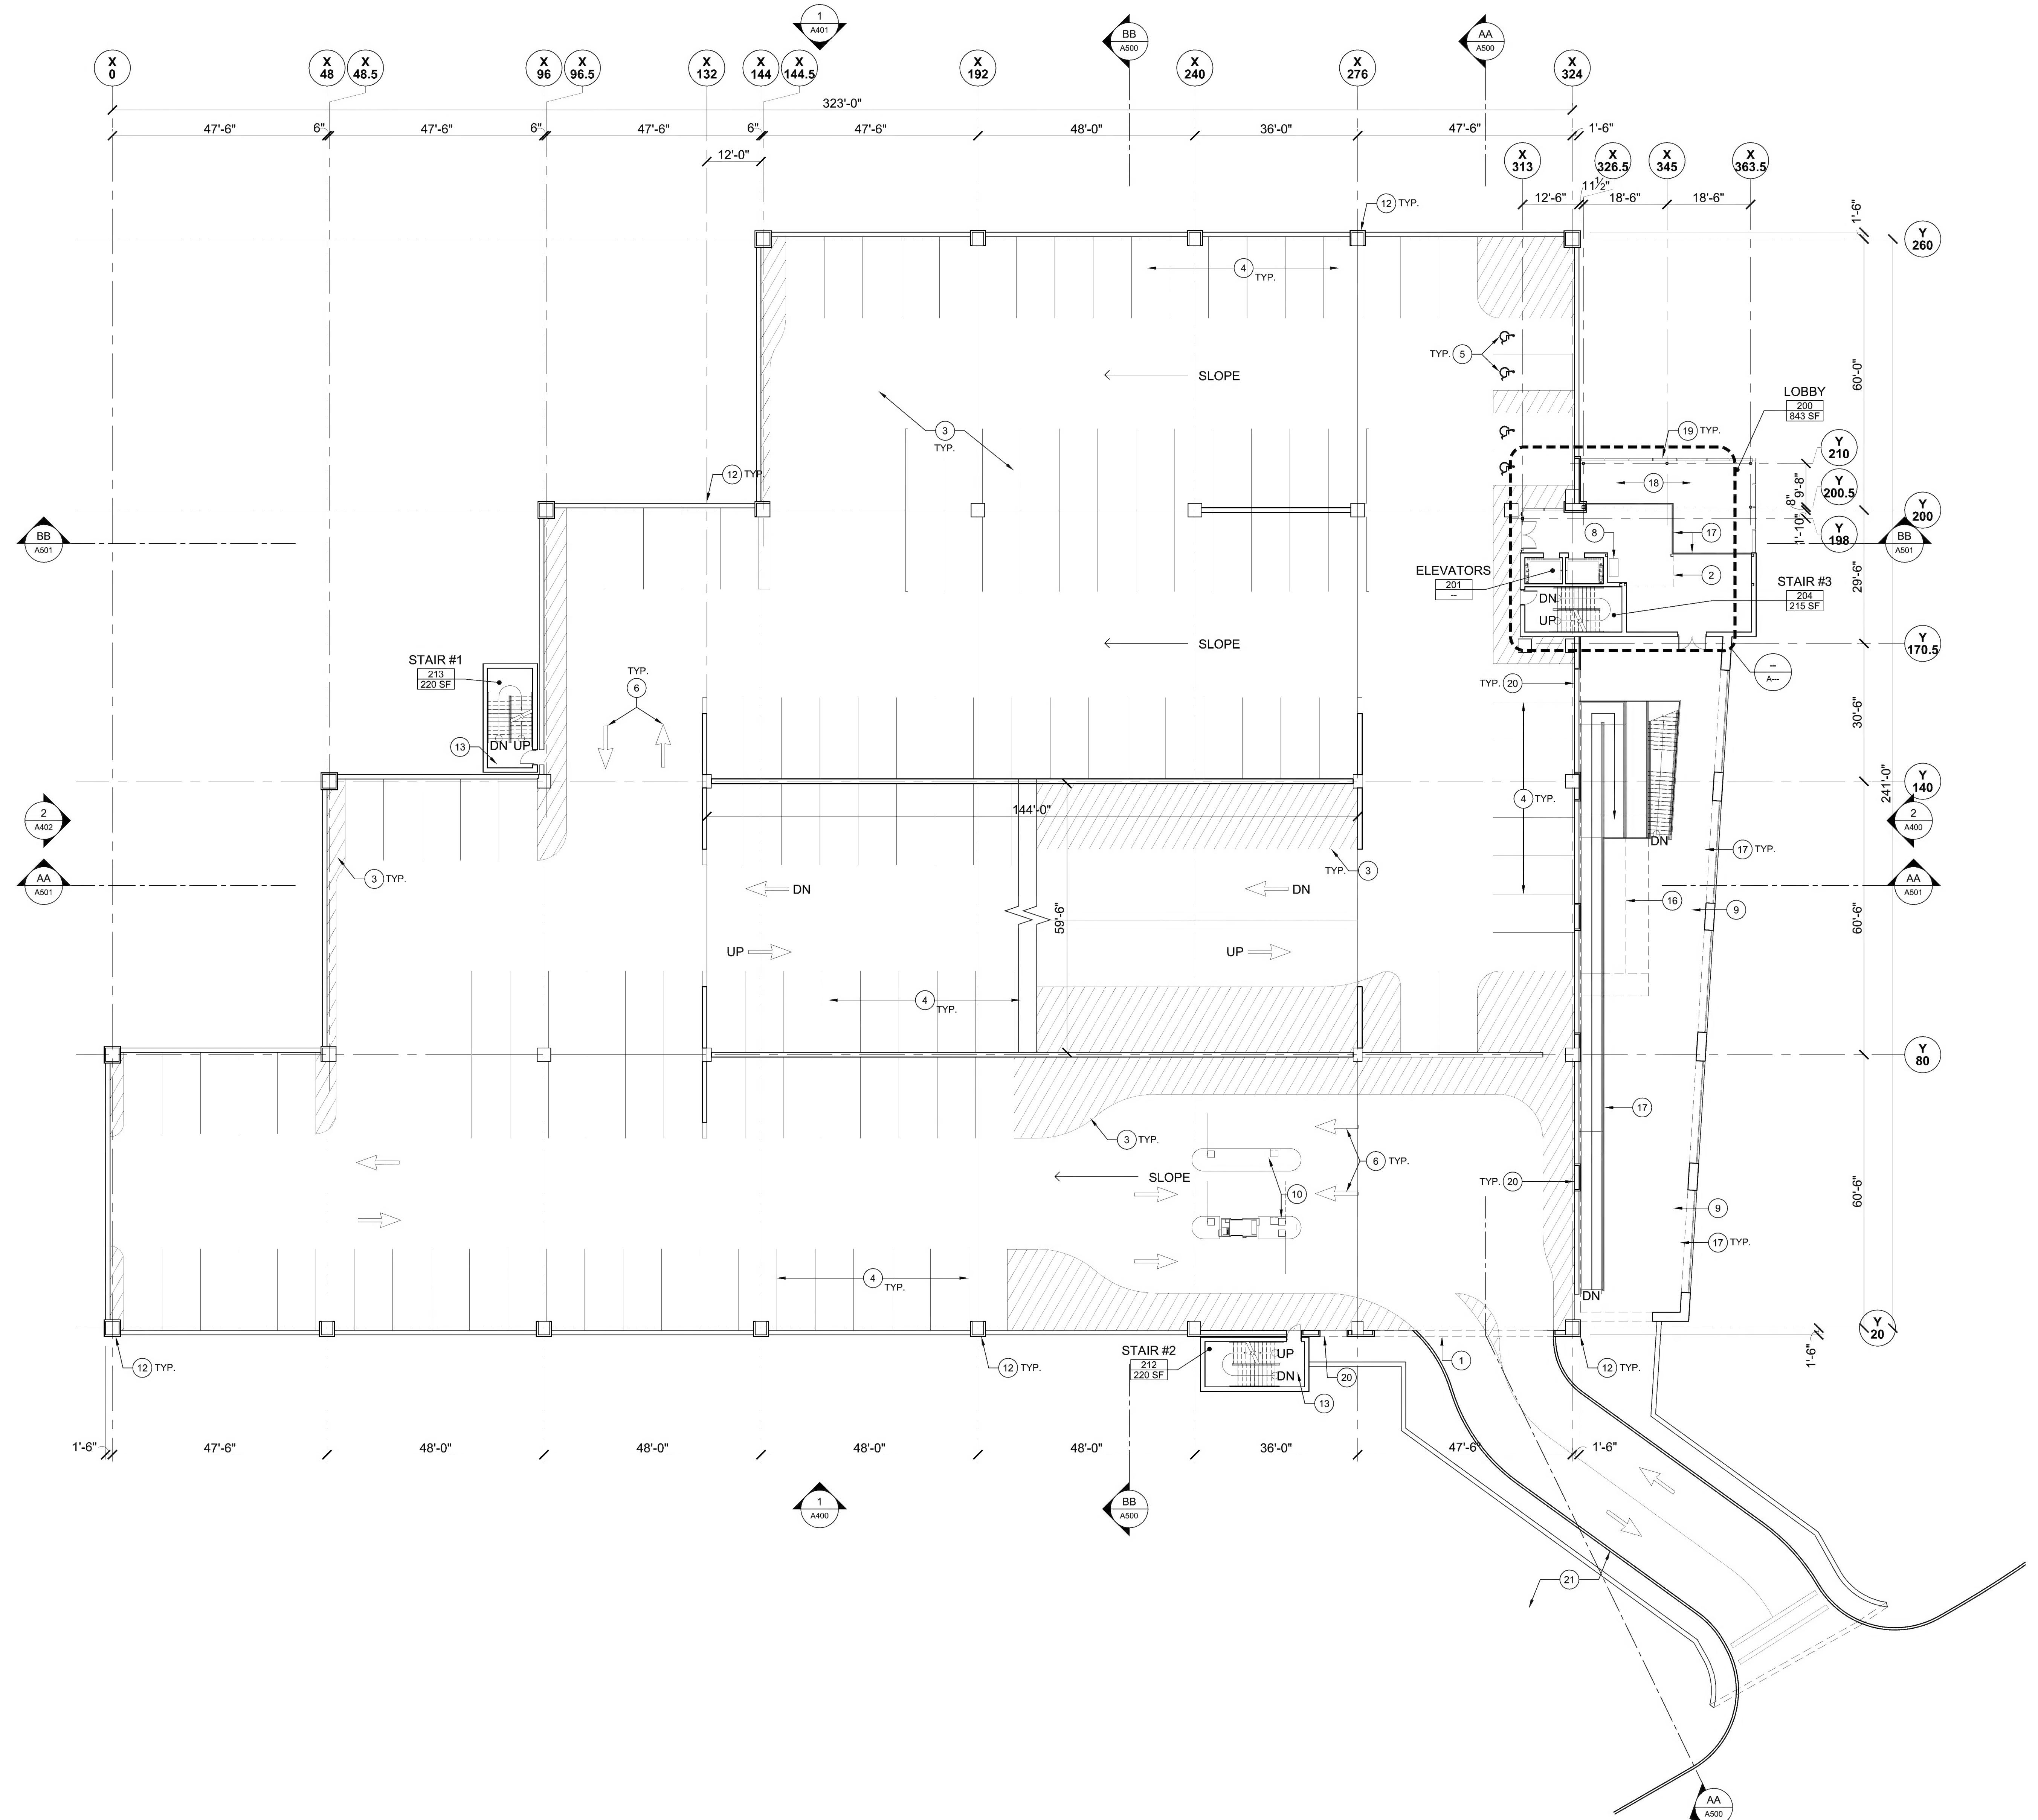

1 | SECOND FLOOR PLAN

1/16" = 1'-0"

LEGEND:		GENERAL CONSTRUCTION NOTES:	
	FULL HEIGHT WALL	A.	REFER TO G003 FOR GENERAL NOTES.
	HALF HEIGHT WALL	B.	REFER TO G004 FOR PARTITION TYPES AND NOTES.
	DASHED LINES INDICATE LINE OF WALL OR SOFFIT ABOVE	C.	REFER TO G003 FOR FINISH NOTES.
		D.	REFER TO G003 FOR REFERENCE SYMBOLS AND TAGS.
		E.	REFER TO ENLARGED PLAN(S) FOR ADDITIONAL PLAN INFORMATION (WALL TAGS, DIMENSIONS, ETC.).
		F.	REFER TO A400'S FOR EXTERIOR ELEVATIONS.
		G.	REFER TO STRUCTURAL DOCUMENTS FOR ADDITIONAL INFORMATION.
		J.	SLAB AT +6" WITHIN ELECTRICAL, PLUMBING / FIRE PROTECTION, COMMUNICATION, AND STORAGE AREAS.
# CONSTRUCTION KEYNOTES:		# CONSTRUCTION KEYNOTES:	
1.	LINE OF SPANDREL ABOVE. REFER TO REFLECTED CEILING PLANS FOR MORE INFORMATION.	1.	LINE OF SPANDREL ABOVE. REFER TO REFLECTED CEILING PLANS FOR MORE INFORMATION.
2.	LINE OF FLOOR ABOVE.	2.	LINE OF FLOOR ABOVE.
3.	HATCHED AREA INDICATES PAINTED STRIPING.	3.	HATCHED AREA INDICATES PAINTED STRIPING.
4.	LINES INDICATE PAINTED LINES.	4.	LINES INDICATE PAINTED LINES.
5.	ACCESSIBILITY ICON INDICATES PAINTED ICON.	5.	ACCESSIBILITY ICON INDICATES PAINTED ICON.
6.	ARROWS INDICATE PAINTED ARROWS.	6.	ARROWS INDICATE PAINTED ARROWS.
7.	DASHED LINES INDICATE CONCRETE RAMP ABOVE.	7.	DASHED LINES INDICATE CONCRETE RAMP ABOVE.
8.	SELF-PAY STATION.	8.	SELF-PAY STATION.
9.	DASHED LINES INDICATE WALL ABOVE	9.	DASHED LINES INDICATE WALL ABOVE
10.	PARKING CONTROL GATES SYSTEM TICKET BOOTH AND TICKET DISPENSER.	10.	PARKING CONTROL GATES SYSTEM TICKET BOOTH AND TICKET DISPENSER.
11.	DASHED LINE INDICATED ENCLOSED BICYCLE PARKING AREA.	11.	DASHED LINE INDICATED ENCLOSED BICYCLE PARKING AREA.
12.	BRICK PLAD STRUCTURAL CONCRETE COLUMNS.	12.	BRICK PLAD STRUCTURAL CONCRETE COLUMNS.
13.	PRE-CAST CONCRETE STAIR TOWER.	13.	PRE-CAST CONCRETE STAIR TOWER.
14.	BRICK CLAD CONCRETE BLOCK (IN-FILL) WALL OVER PRE-CAST GRADE SPANDREL.	14.	BRICK CLAD CONCRETE BLOCK (IN-FILL) WALL OVER PRE-CAST GRADE SPANDREL.
15.	BRICK CLAD PRE-CAST GRADE SPANDREL WITH PRE-CAST CAP.	15.	BRICK CLAD PRE-CAST GRADE SPANDREL WITH PRE-CAST CAP.
16.	DASHED LINES INDICATE CONCRETE RAMP BELOW.	16.	DASHED LINES INDICATE CONCRETE RAMP BELOW.
17.	LINES OF GUARDRAIL AT OPENING TO BELOW.	17.	LINES OF GUARDRAIL AT OPENING TO BELOW.
18.	AREA OPEN TO BELOW.	18.	AREA OPEN TO BELOW.
19.	CURTAIN WALL SYSTEM AT LOBBY ENCLOSURE.	19.	CURTAIN WALL SYSTEM AT LOBBY ENCLOSURE.
20.	BRICK CLAD PRE-CAST SPANDREL.	20.	BRICK CLAD PRE-CAST SPANDREL.
21.	CONCRETE AND STEEL BRIDGE TO SECOND LEVEL OF PARKING GARAGE. REFER TO STRUCTURAL DOCUMENTS FOR MORE INFORMATION.	21.	CONCRETE AND STEEL BRIDGE TO SECOND LEVEL OF PARKING GARAGE. REFER TO STRUCTURAL DOCUMENTS FOR MORE INFORMATION.
22.	DASHED LINES INDICATE STEEL STRUCTURE ABOVE.	22.	DASHED LINES INDICATE STEEL STRUCTURE ABOVE.
23.	LINES INDICATE STANDING SEAM METAL ROOF BELOW.	23.	LINES INDICATE STANDING SEAM METAL ROOF BELOW.
24.	EDGE OF PARKING STRUCTURE BELOW.	24.	EDGE OF PARKING STRUCTURE BELOW.
25.	TOP OF STAIR TOWER BELOW.	25.	TOP OF STAIR TOWER BELOW.
26.	EDGE OF CLAD SPANDREL / CORNICE.	26.	EDGE OF CLAD SPANDREL / CORNICE.
27.	DASHED LINE OF CANOPY ABOVE.	27.	DASHED LINE OF CANOPY ABOVE.

MASSACHUSETTS BAY TRANSPORTATION AUTHORITY  
SALEM COMMUTER RAIL STATION INTERMODAL CENTER  
SALEM, MASSACHUSETTS

SECOND FLOOR PLAN

AECOM

38 CHAUNCEY STREET  
TENTH FLOOR SUITE 1001  
BOSTON, MASSACHUSETTS 02111  
617.482.4835

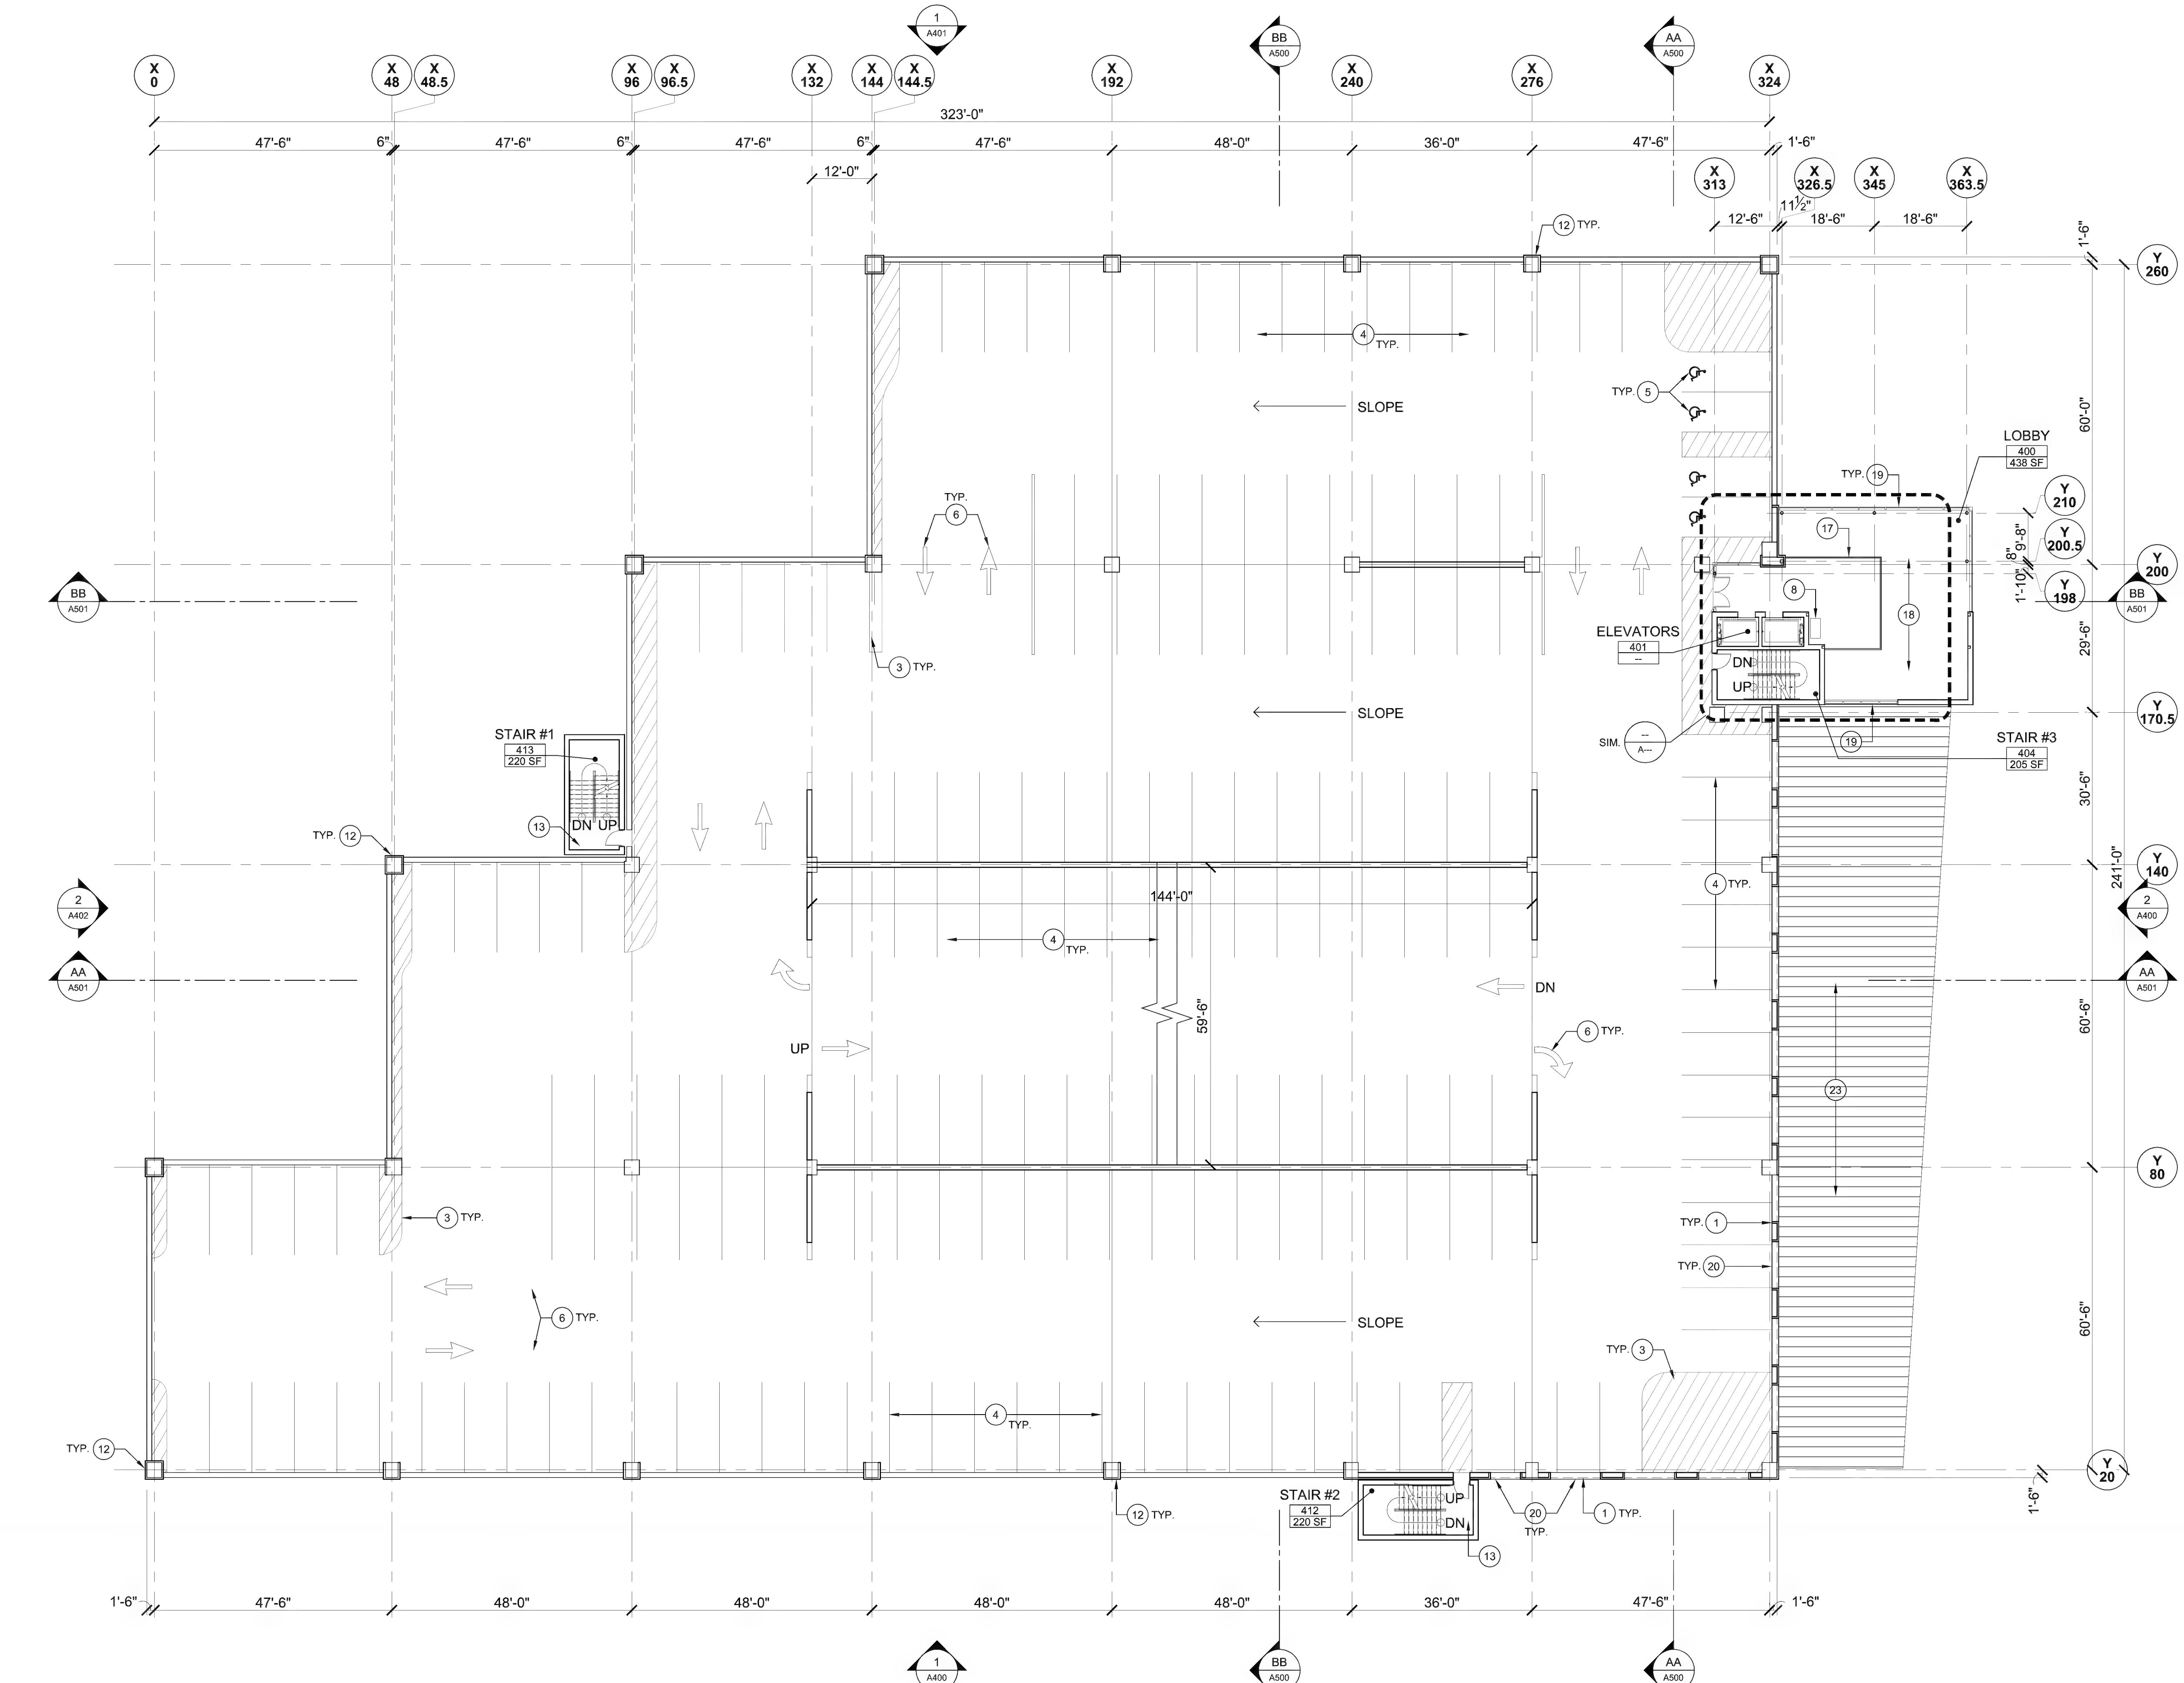
LEGEND:  
FULL HEIGHT WALL  
HALF HEIGHT WALL  
DASHED LINES INDICATE LINE OF WALL OR SOFFIT ABOVE

JK 12/16/2009  
JGMH CRK DATE  
1 30% DESIGN SUBMISSION  
REV. DESCRIPTION  
1 30% DESIGN SUBMISSION


1-INCH  
PLAN SHEET  
MEASUREMENT GUIDE  
PROJECT START DATE JUNE 2009  
PROJECT NO. 113157  
DRAWING NO.

A201





LEGEND:	
	FULL HEIGHT WALL
	HALF HEIGHT WALL
	DASHED LINES INDICATE LINE OF WALL OR SOFFIT ABOVE
GENERAL CONSTRUCTION NOTES:	
A.	REFER TO G003 FOR GENERAL NOTES.
B.	REFER TO G004 FOR PARTITION TYPES AND NOTES.
C.	REFER TO G003 FOR FINISH NOTES.
D.	REFER TO G003 FOR REFERENCE SYMBOLS AND TAGS.
E.	REFER TO ENLARGED PLAN(S) FOR ADDITIONAL PLAN INFORMATION (WALL TAGS, DIMENSIONS, ETC.).
F.	REFER TO A400'S FOR EXTERIOR ELEVATIONS.
G.	REFER TO A500'S FOR BUILDING SECTIONS.
H.	REFER TO STRUCTURAL DOCUMENTS FOR ADDITIONAL INFORMATION.
J.	SLAB AT +6" WITHIN ELECTRICAL, PLUMBING / FIRE PROTECTION, COMMUNICATION, AND STORAGE AREAS.
GENERAL INFORMATION:	
JGM/H	JK
12/16/2009	DATE
1	30% DESIGN SUBMISSION
REV. DESCRIPTION	REV. DESCRIPTION
CONSULTANT:	CONSULTANT:
STAMP:	STAMP:
# CONSTRUCTION KEYNOTES:	
1.	LINE OF SPANDREL ABOVE. REFER TO REFLECTED CEILING PLANS FOR MORE INFORMATION.
2.	LINE OF FLOOR ABOVE.
3.	HATCHED AREA INDICATES PAINTED STRIPING.
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18.	AREA OPEN TO BELOW.
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20.	BRICK CLAD PRE-CAST SPANDREL.
21.	CONCRETE AND STEEL BRIDGE TO SECOND LEVEL OF PARKING GARAGE. REFER TO STRUCTURAL DOCUMENTS FOR MORE INFORMATION.
22.	DASHED LINES INDICATE STEEL STRUCTURE ABOVE.
23.	LINES INDICATE STANDING SEAM METAL ROOF BELOW.
24.	EDGE OF PARKING STRUCTURE BELOW.
25.	TOP OF STAIR TOWER BELOW.
26.	EDGE OF CLAD SPANDREL / CORNICE.
27.	DASHED LINE OF CANOPY ABOVE.
MASSACHUSETTS BAY TRANSPORTATION AUTHORITY SALEM COMMUTER RAIL STATION INTERMODAL CENTER SALEM, MASSACHUSETTS	
FOURTH FLOOR PLAN	
AECOM	
38 CHAUNCEY STREET TENTH FLOOR SUITE 1001 BOSTON, MASSACHUSETTS 02111 617.482.4835	
1-INCH PLAN SHEET MEASUREMENT GUIDE	
PROJECT START DATE JUNE 2009	
PROJECT NO. 113157	
DRAWING NO. A203	

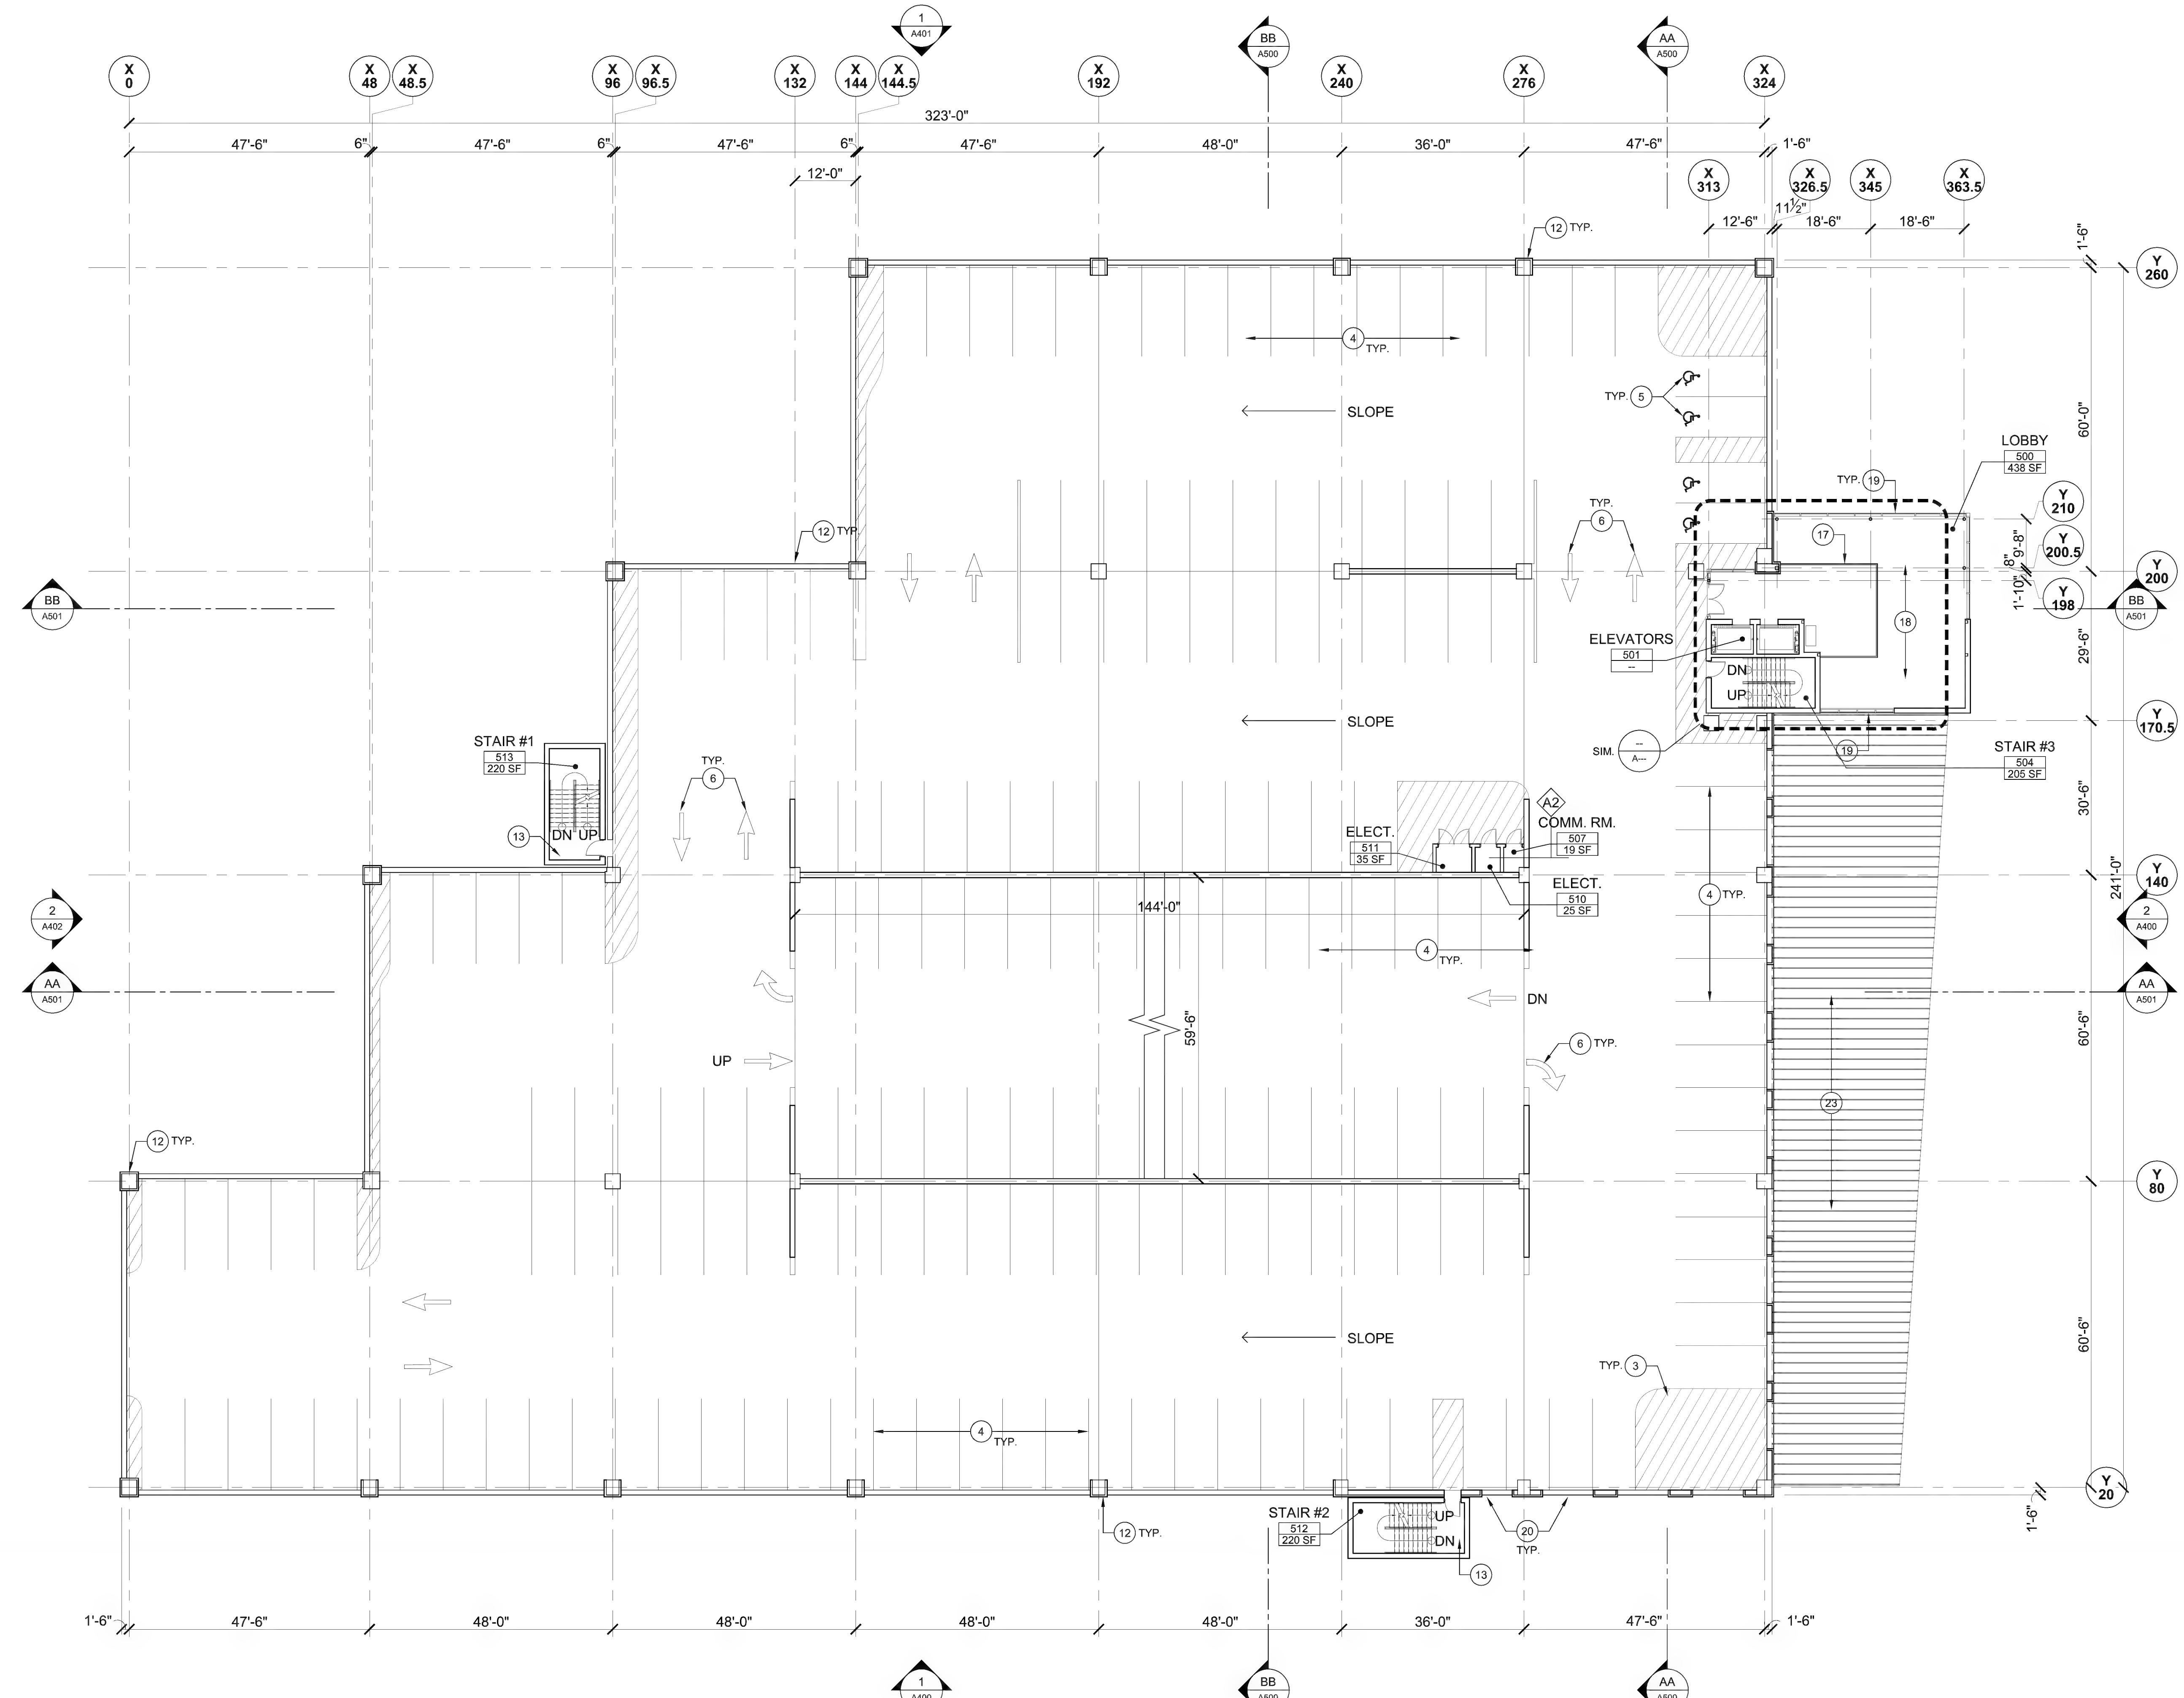

## 1 | FIFTH FLOOR PLAN

1/16" = 1'-0"

**LEGEND:**

 FULL HEIGHT WALL

 HALF HEIGHT WALL

 DASHED LINES INDICATE LINE OF WALL OR SOFFIT ABOVE

**GENERAL CONSTRUCTION NOTES:**

- REFER TO G003 FOR GENERAL NOTES.
- REFER TO G004 FOR PARTITION TYPES AND NOTES.
- REFER TO G003 FOR FINISH NOTES.
- REFER TO G003 FOR REFERENCE SYMBOLS AND TAGS.
- REFER TO ENLARGED PLAN(S) FOR ADDITIONAL PLAN INFORMATION (WALL TAGS, DIMENSIONS, ETC.).
- REFER TO A400'S FOR EXTERIOR ELEVATIONS.
- REFER TO A500'S FOR BUILDING SECTIONS.
- REFER TO STRUCTURAL DOCUMENTS FOR ADDITIONAL INFORMATION.
- SLAB AT +6" WITHIN ELECTRICAL, PLUMBING / FIRE PROTECTION, COMMUNICATION, AND STORAGE AREAS.

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**MASSACHUSETTS BAY TRANSPORTATION AUTHORITY  
SALEM COMMUTER RAIL STATION INTERMODAL CENTER  
SALEM, MASSACHUSETTS**

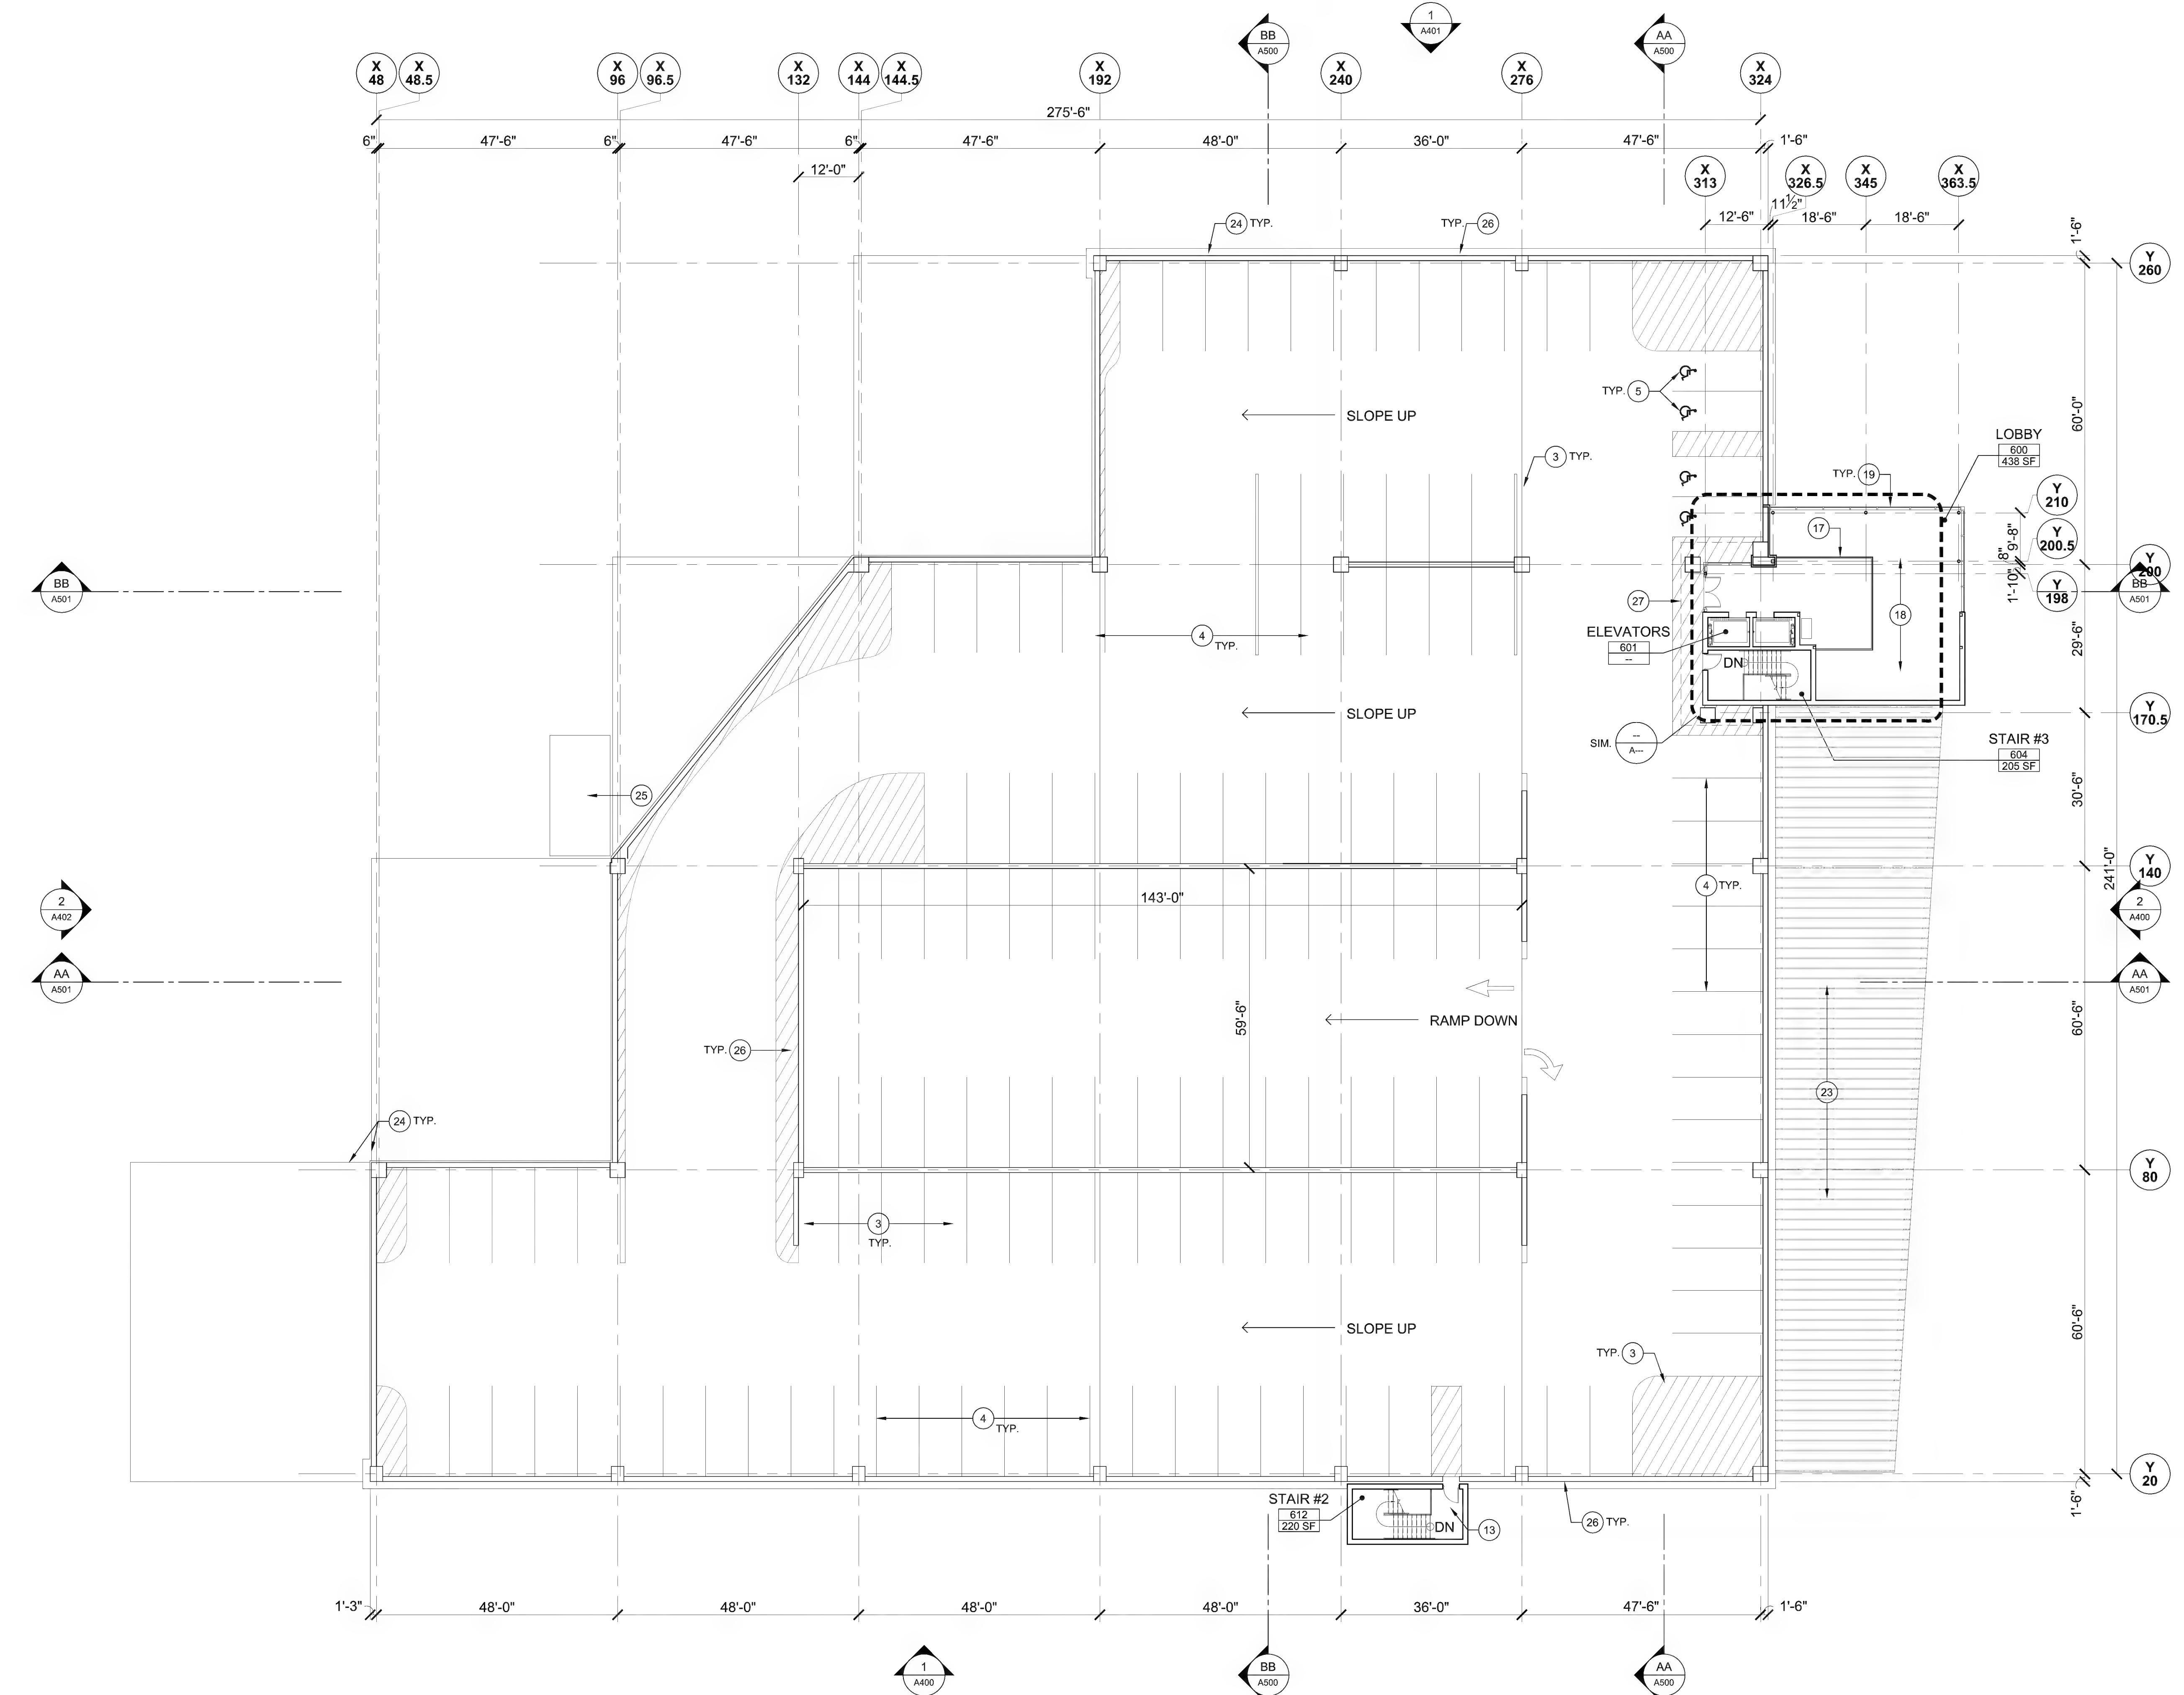
AV.COM

111

38 CHAUNCY STREET  
TENTH FLOOR, SUITE 1004

100

204




## 1 | SIXTH FLOOR PLAN

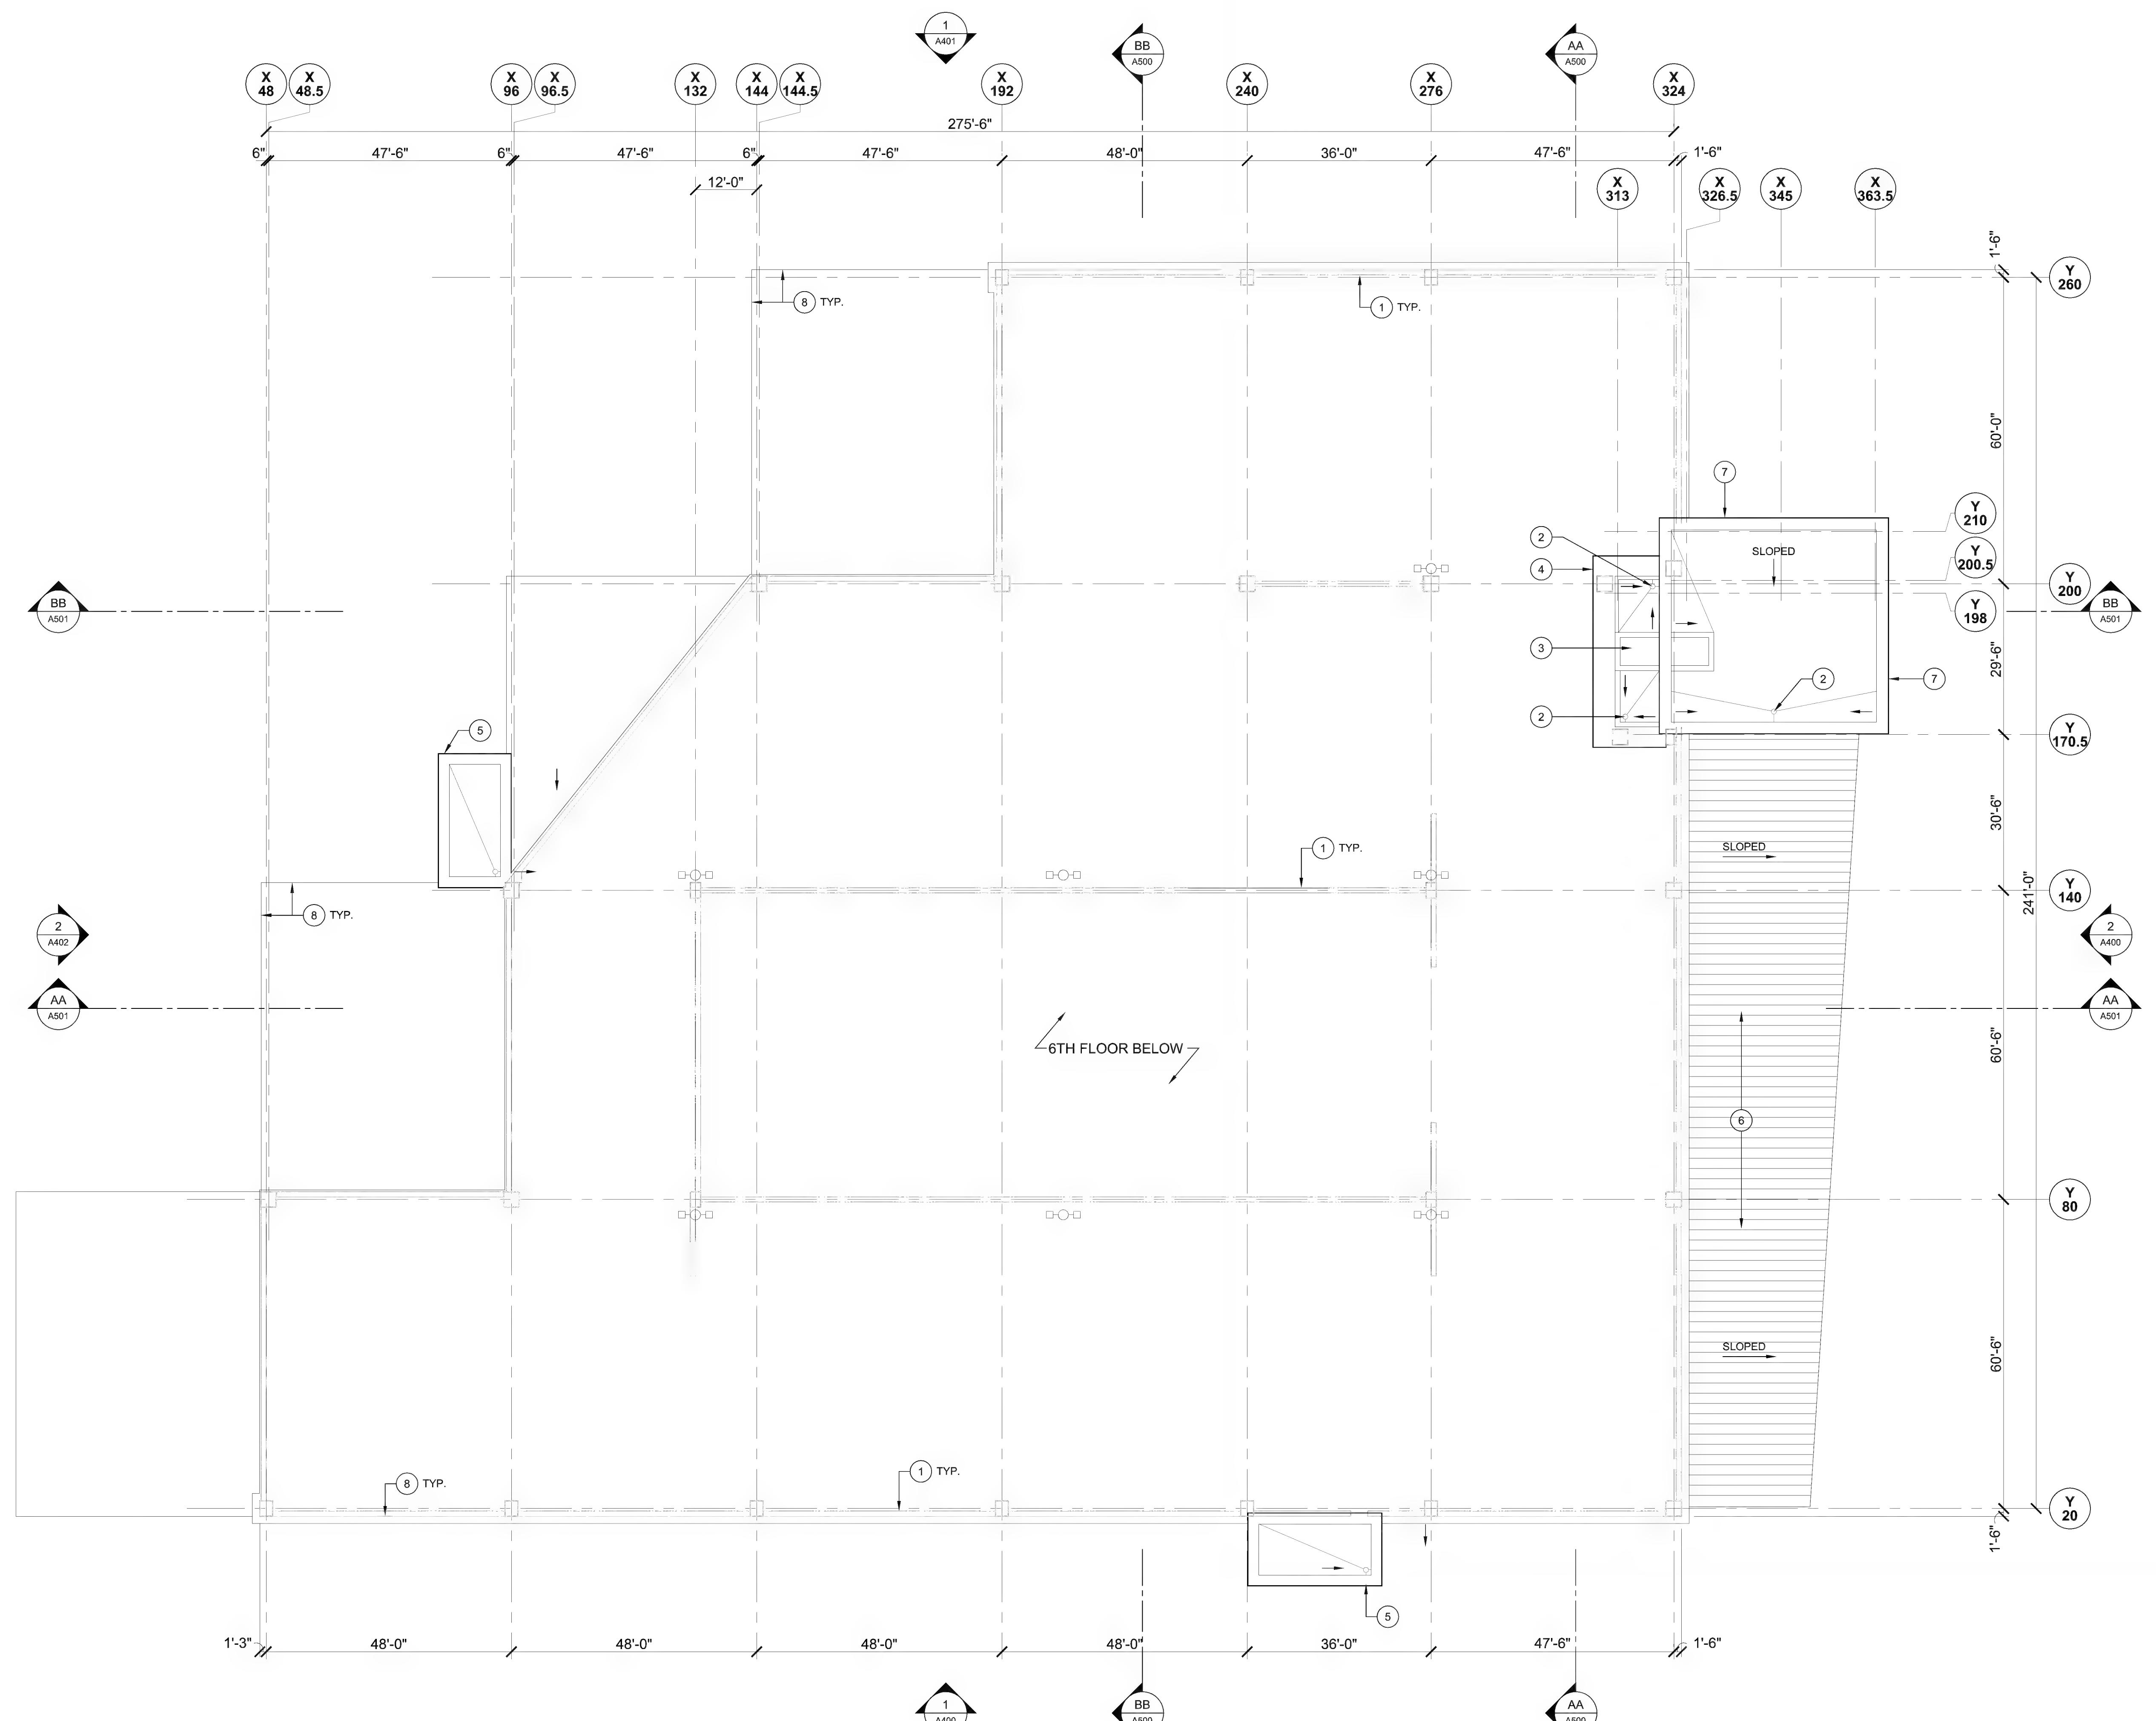1/16" = 1'-0"

<b>LEGEND:</b> <ul style="list-style-type: none"> <li><input type="checkbox"/> FULL HEIGHT WALL</li> <li><input type="checkbox"/> HALF HEIGHT WALL</li> <li><input type="checkbox"/> DASHED LINES INDICATE LINE OF WALL OR SOFFIT ABOVE</li> </ul>																																																																																										
<b>GENERAL CONSTRUCTION NOTES:</b> <p>REFER TO G003 FOR GENERAL NOTES.</p> <p>REFER TO G004 FOR PARTITION TYPES AND NOTES.</p> <p>REFER TO G003 FOR FINISH NOTES.</p> <p>REFER TO G003 FOR REFERENCE SYMBOLS AND TAGS.</p> <p>REFER TO ENLARGED PLAN(S) FOR ADDITIONAL PLAN INFORMATION (WALL TAGS, DIMENSIONS, ETC.).</p> <p>REFER TO A400'S FOR EXTERIOR ELEVATIONS.</p> <p>REFER TO A500'S FOR BUILDING SECTIONS.</p> <p>REFER TO STRUCTURAL DOCUMENTS FOR ADDITIONAL INFORMATION.</p> <p>SLAB AT +6" WITHIN ELECTRICAL, PLUMBING / FIRE PROTECTION, COMMUNICATION, AND STORAGE AREAS.</p>																																																																																										
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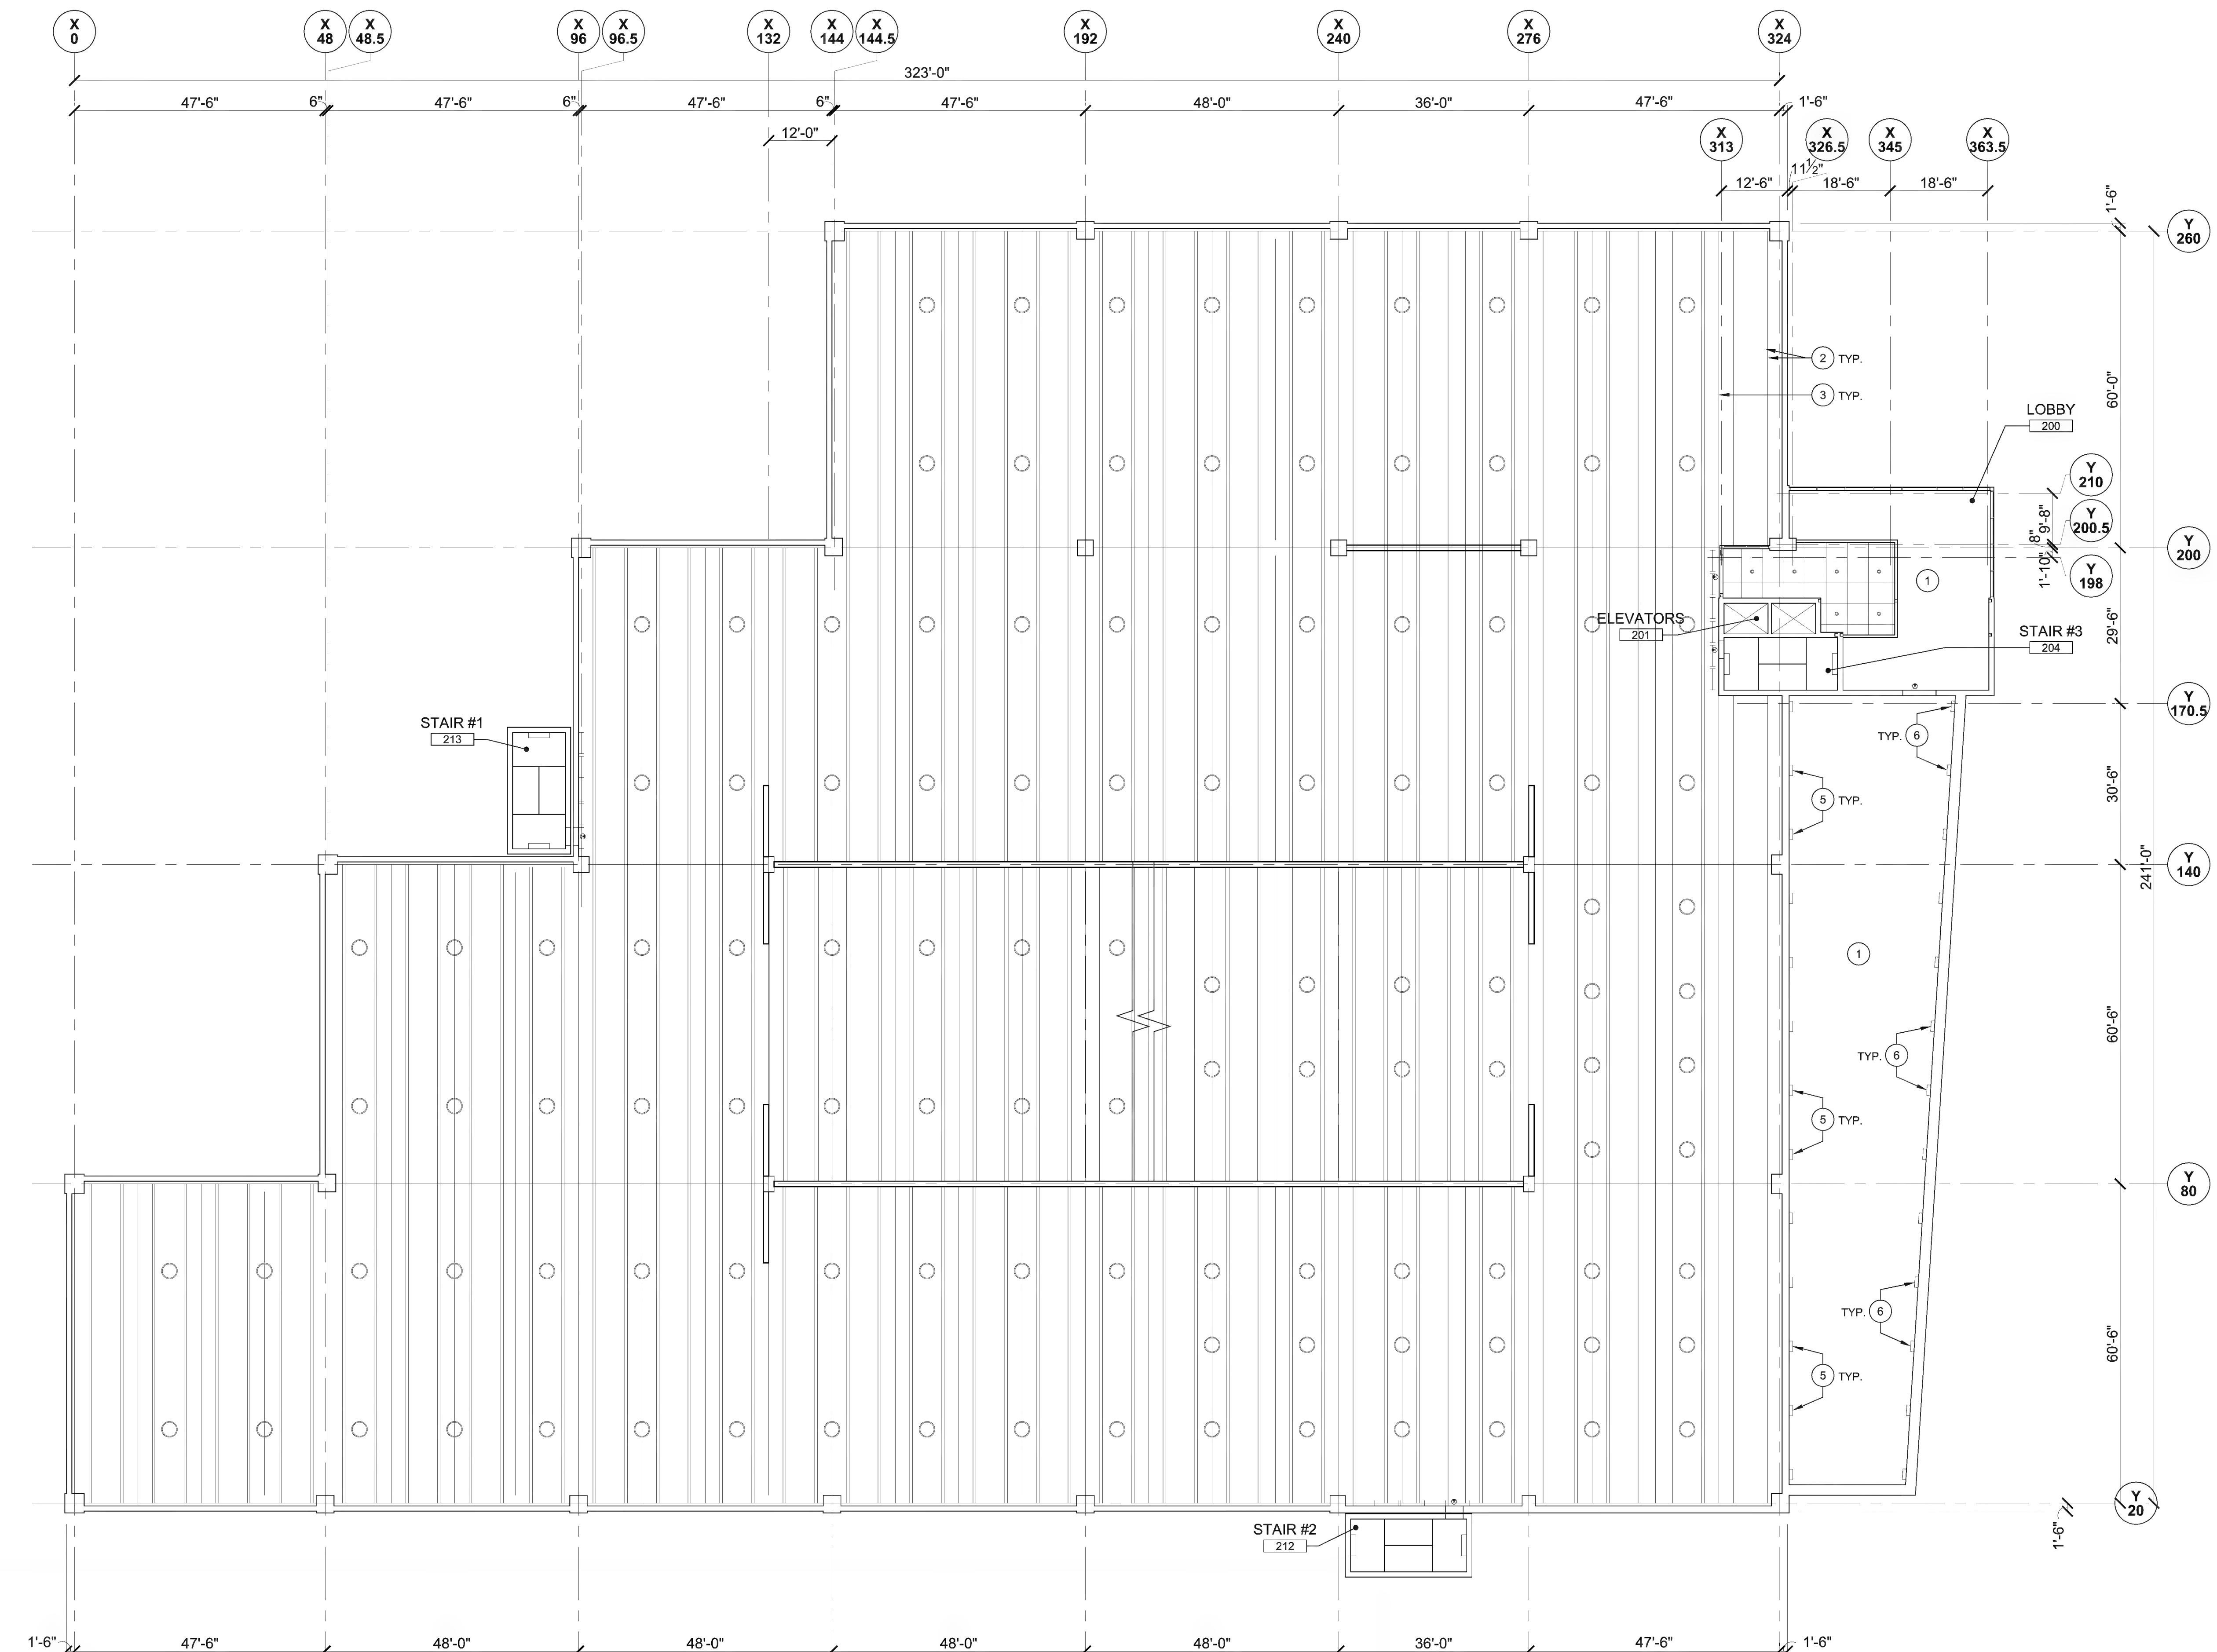
1 | ROOF PLAN

1/16" = 1'-0"

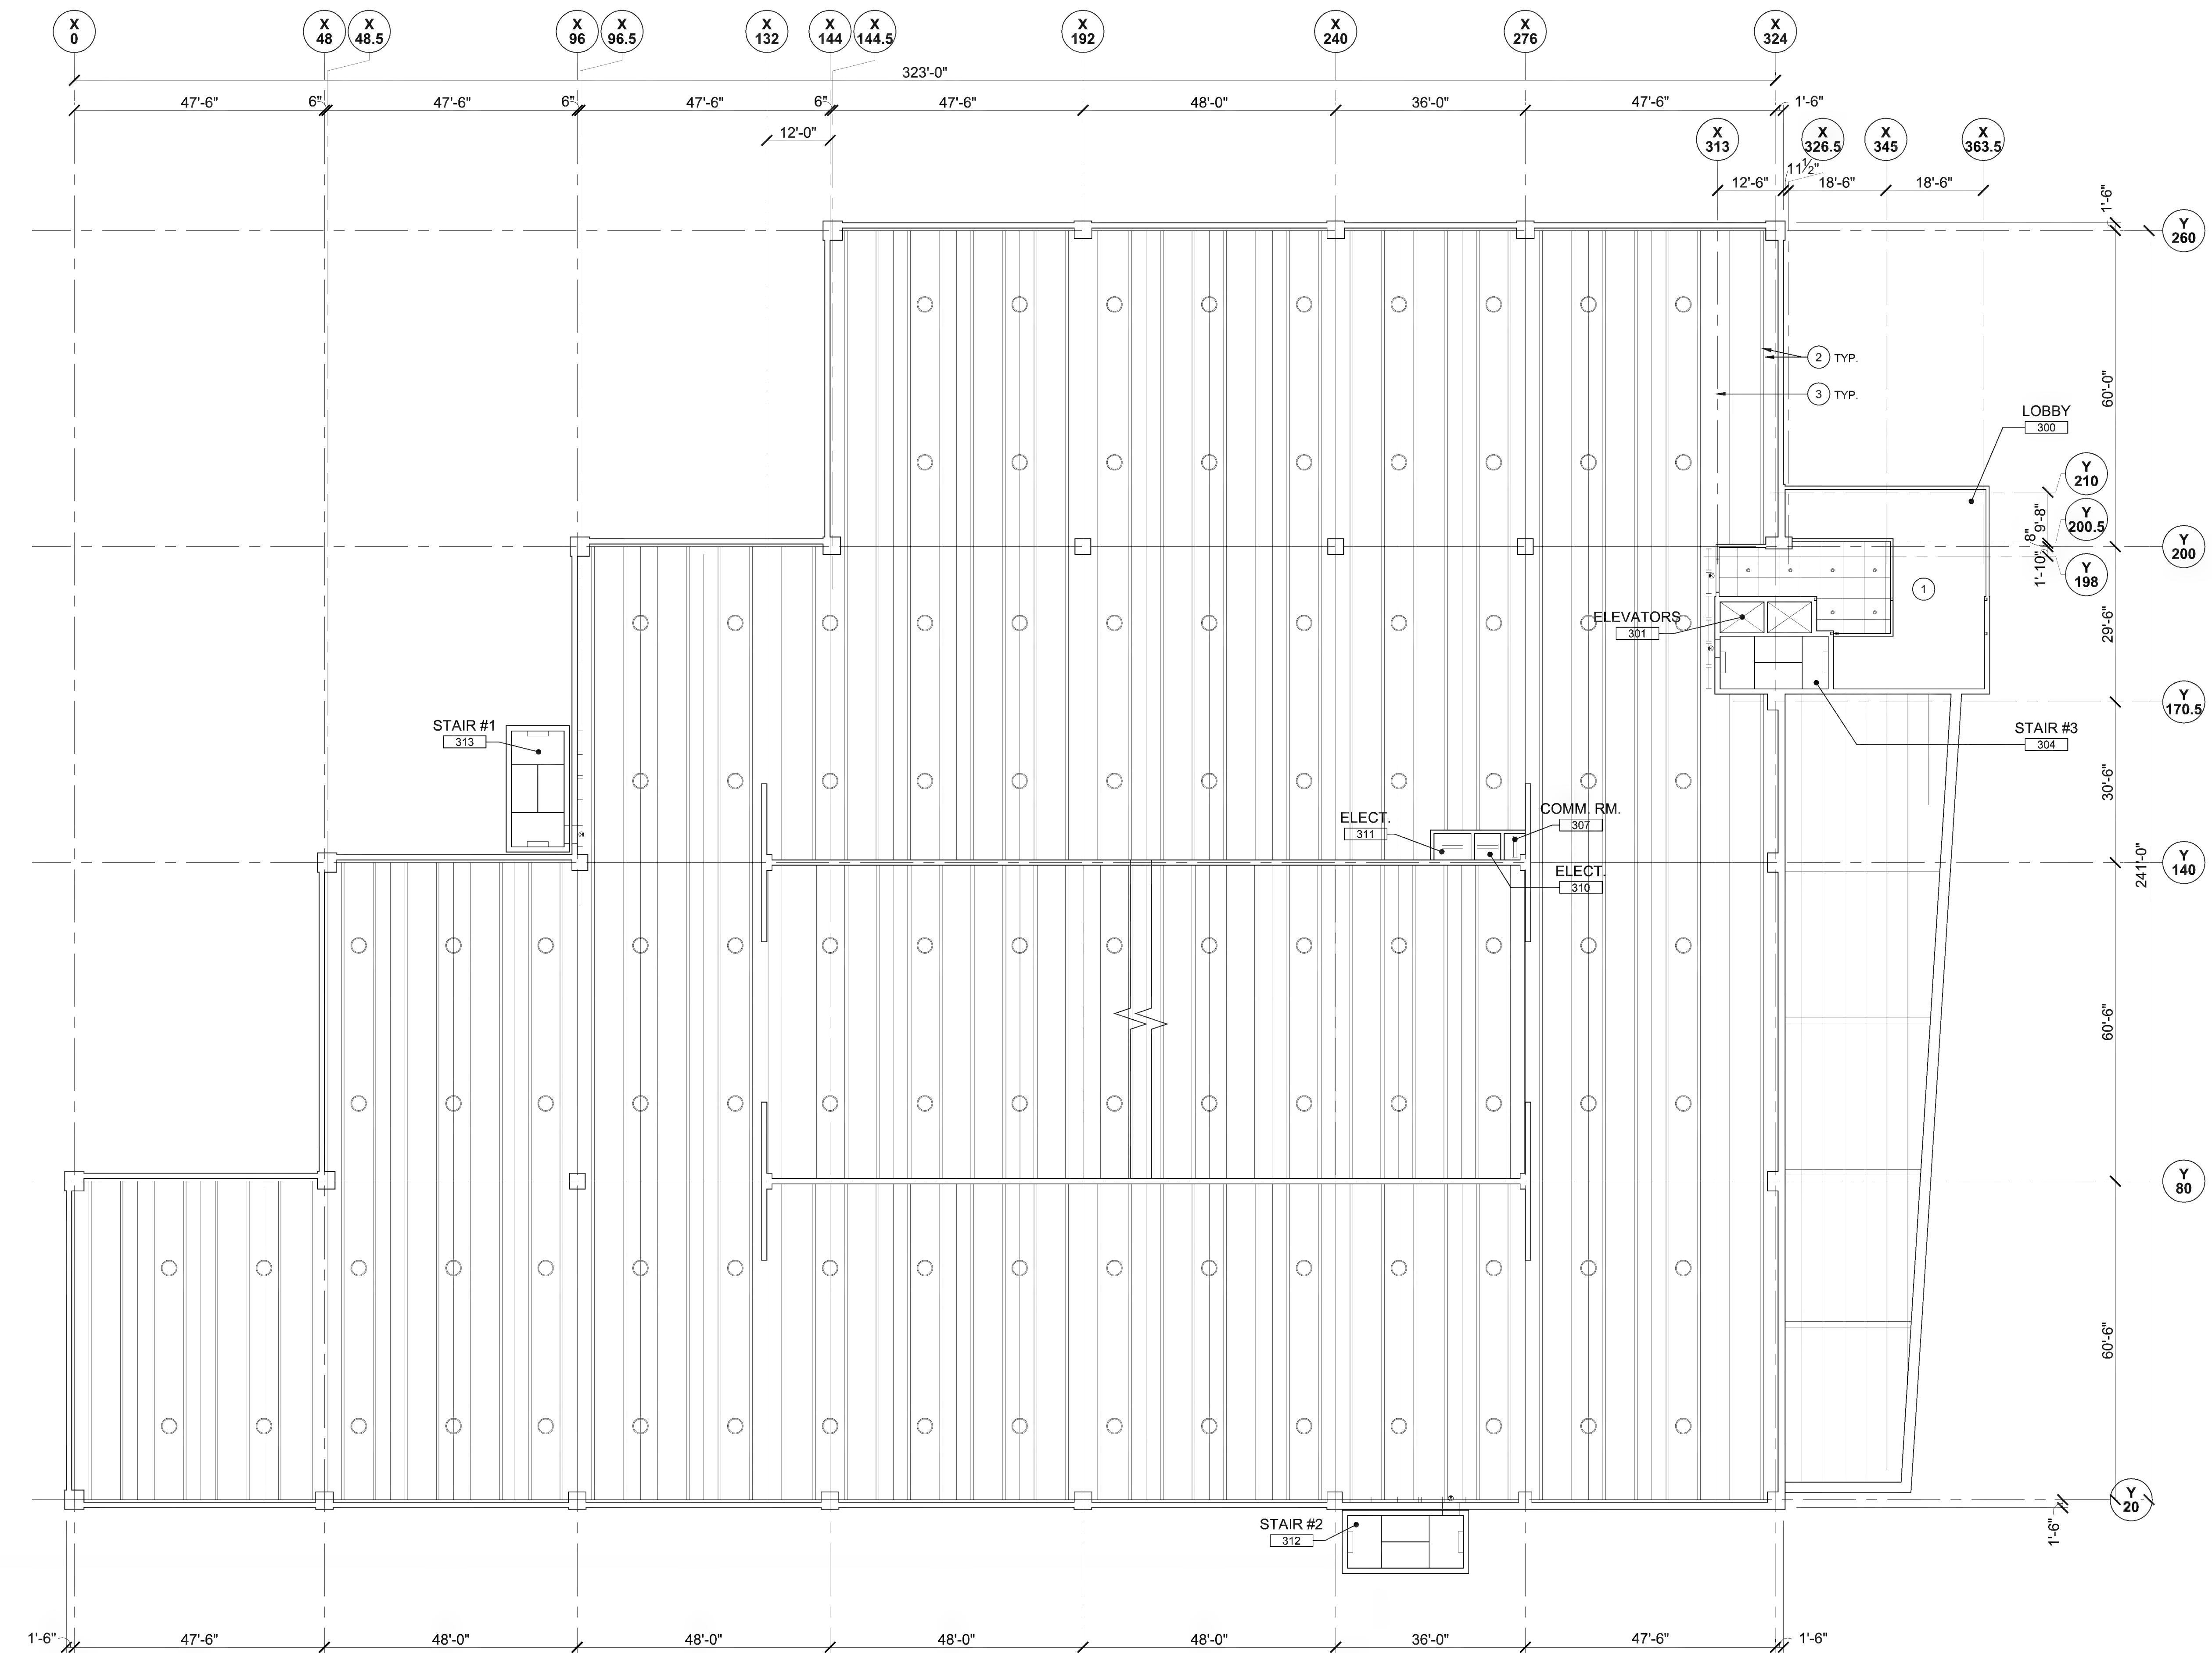
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B.	REFER TO G003 FOR REFERENCE SYMBOLS AND TAGS.	EDGE OF ROOF AND/OR PARAPET	
C.	REFER TO STRUCTURAL DOCUMENTS FOR ADDITIONAL INFORMATION.	LINES INDICATE STANDING SEAM METAL ROOF	
D.	STANDING SEAM METAL ROOF TO BE PROVIDED WITH SNOW AND ICE STAYS.		
#		GENERAL CONSTRUCTION NOTES:	
1.	LINE OF WALLS BELOW. REFER TO SIXTH FLOOR PLAN FOR MORE INFORMATION.	A. REFER TO G003 FOR GENERAL NOTES	
2.	ROOF DRAIN. REFER TO PLUMBING DOCUMENTS FOR MORE INFORMATION.	B. REFER TO G003 FOR REFERENCE SYMBOLS AND TAGS.	
3.	TOP OF ELEVATOR SHAFT.	C. REFER TO STRUCTURAL DOCUMENTS FOR ADDITIONAL INFORMATION.	
4.	EDGE OF CANOPY AT ENTRY TO LOBBY AND STAIRS.	D. STANDING SEAM METAL ROOF TO BE PROVIDED WITH SNOW AND ICE STAYS.	
5.	STAIR TOWER ROOF WITH PARAPET / CORNICE.		
6.	LINES OF STANDING SEAM METAL ROOF BELOW.		
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38 CHAUNCEY STREET		12/16/2009	
TENTH FLOOR SUITE 1001		JK	
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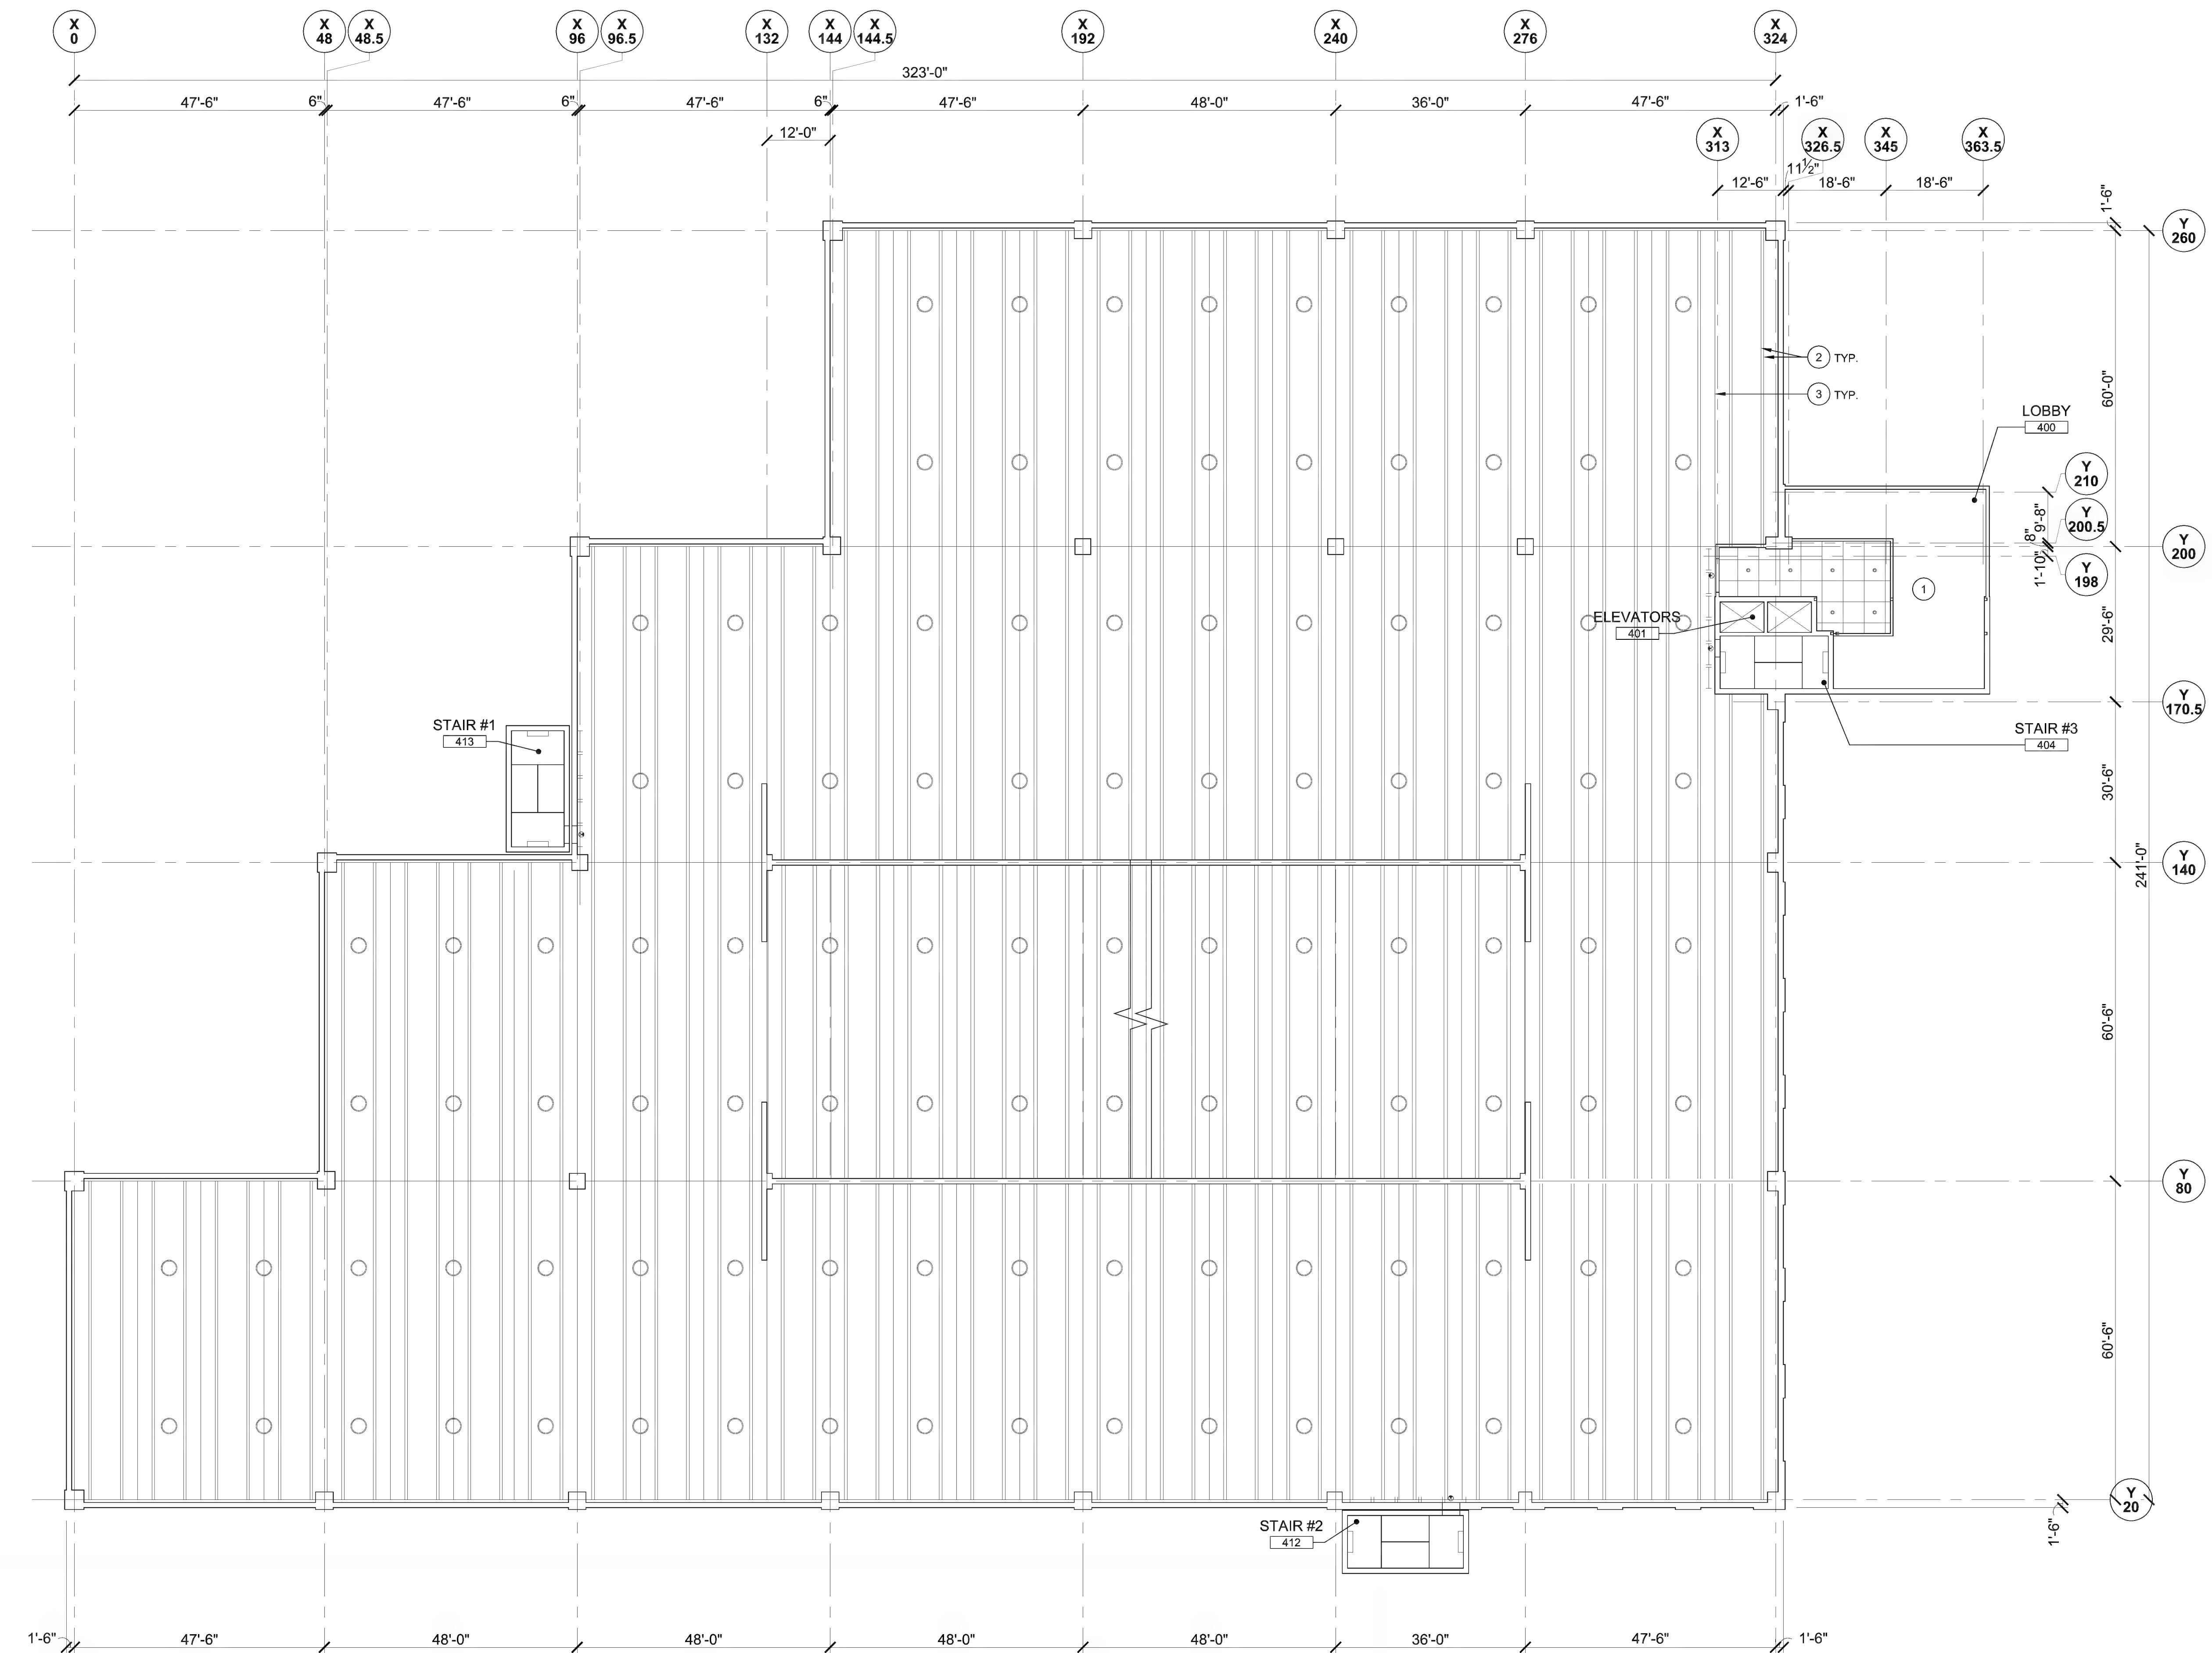
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<b>MASSACHUSETTS BAY TRANSPORTATION AUTHORITY SALEM COMMUTER RAIL STATION INTERMODAL CENTER SALEM, MASSACHUSETTS</b>			
FIRST FLOOR REFLECTED CEILING PLAN			
1-INCH PLAN SHEET MEASUREMENT GUIDE			
PROJECT START DATE JUNE 2009			
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DRAWING NO. A300			
38 CHAUNCEY STREET TENTH FLOOR, SUITE 1001 BOSTON, MASSACHUSETTS 02111 617.482.4835			
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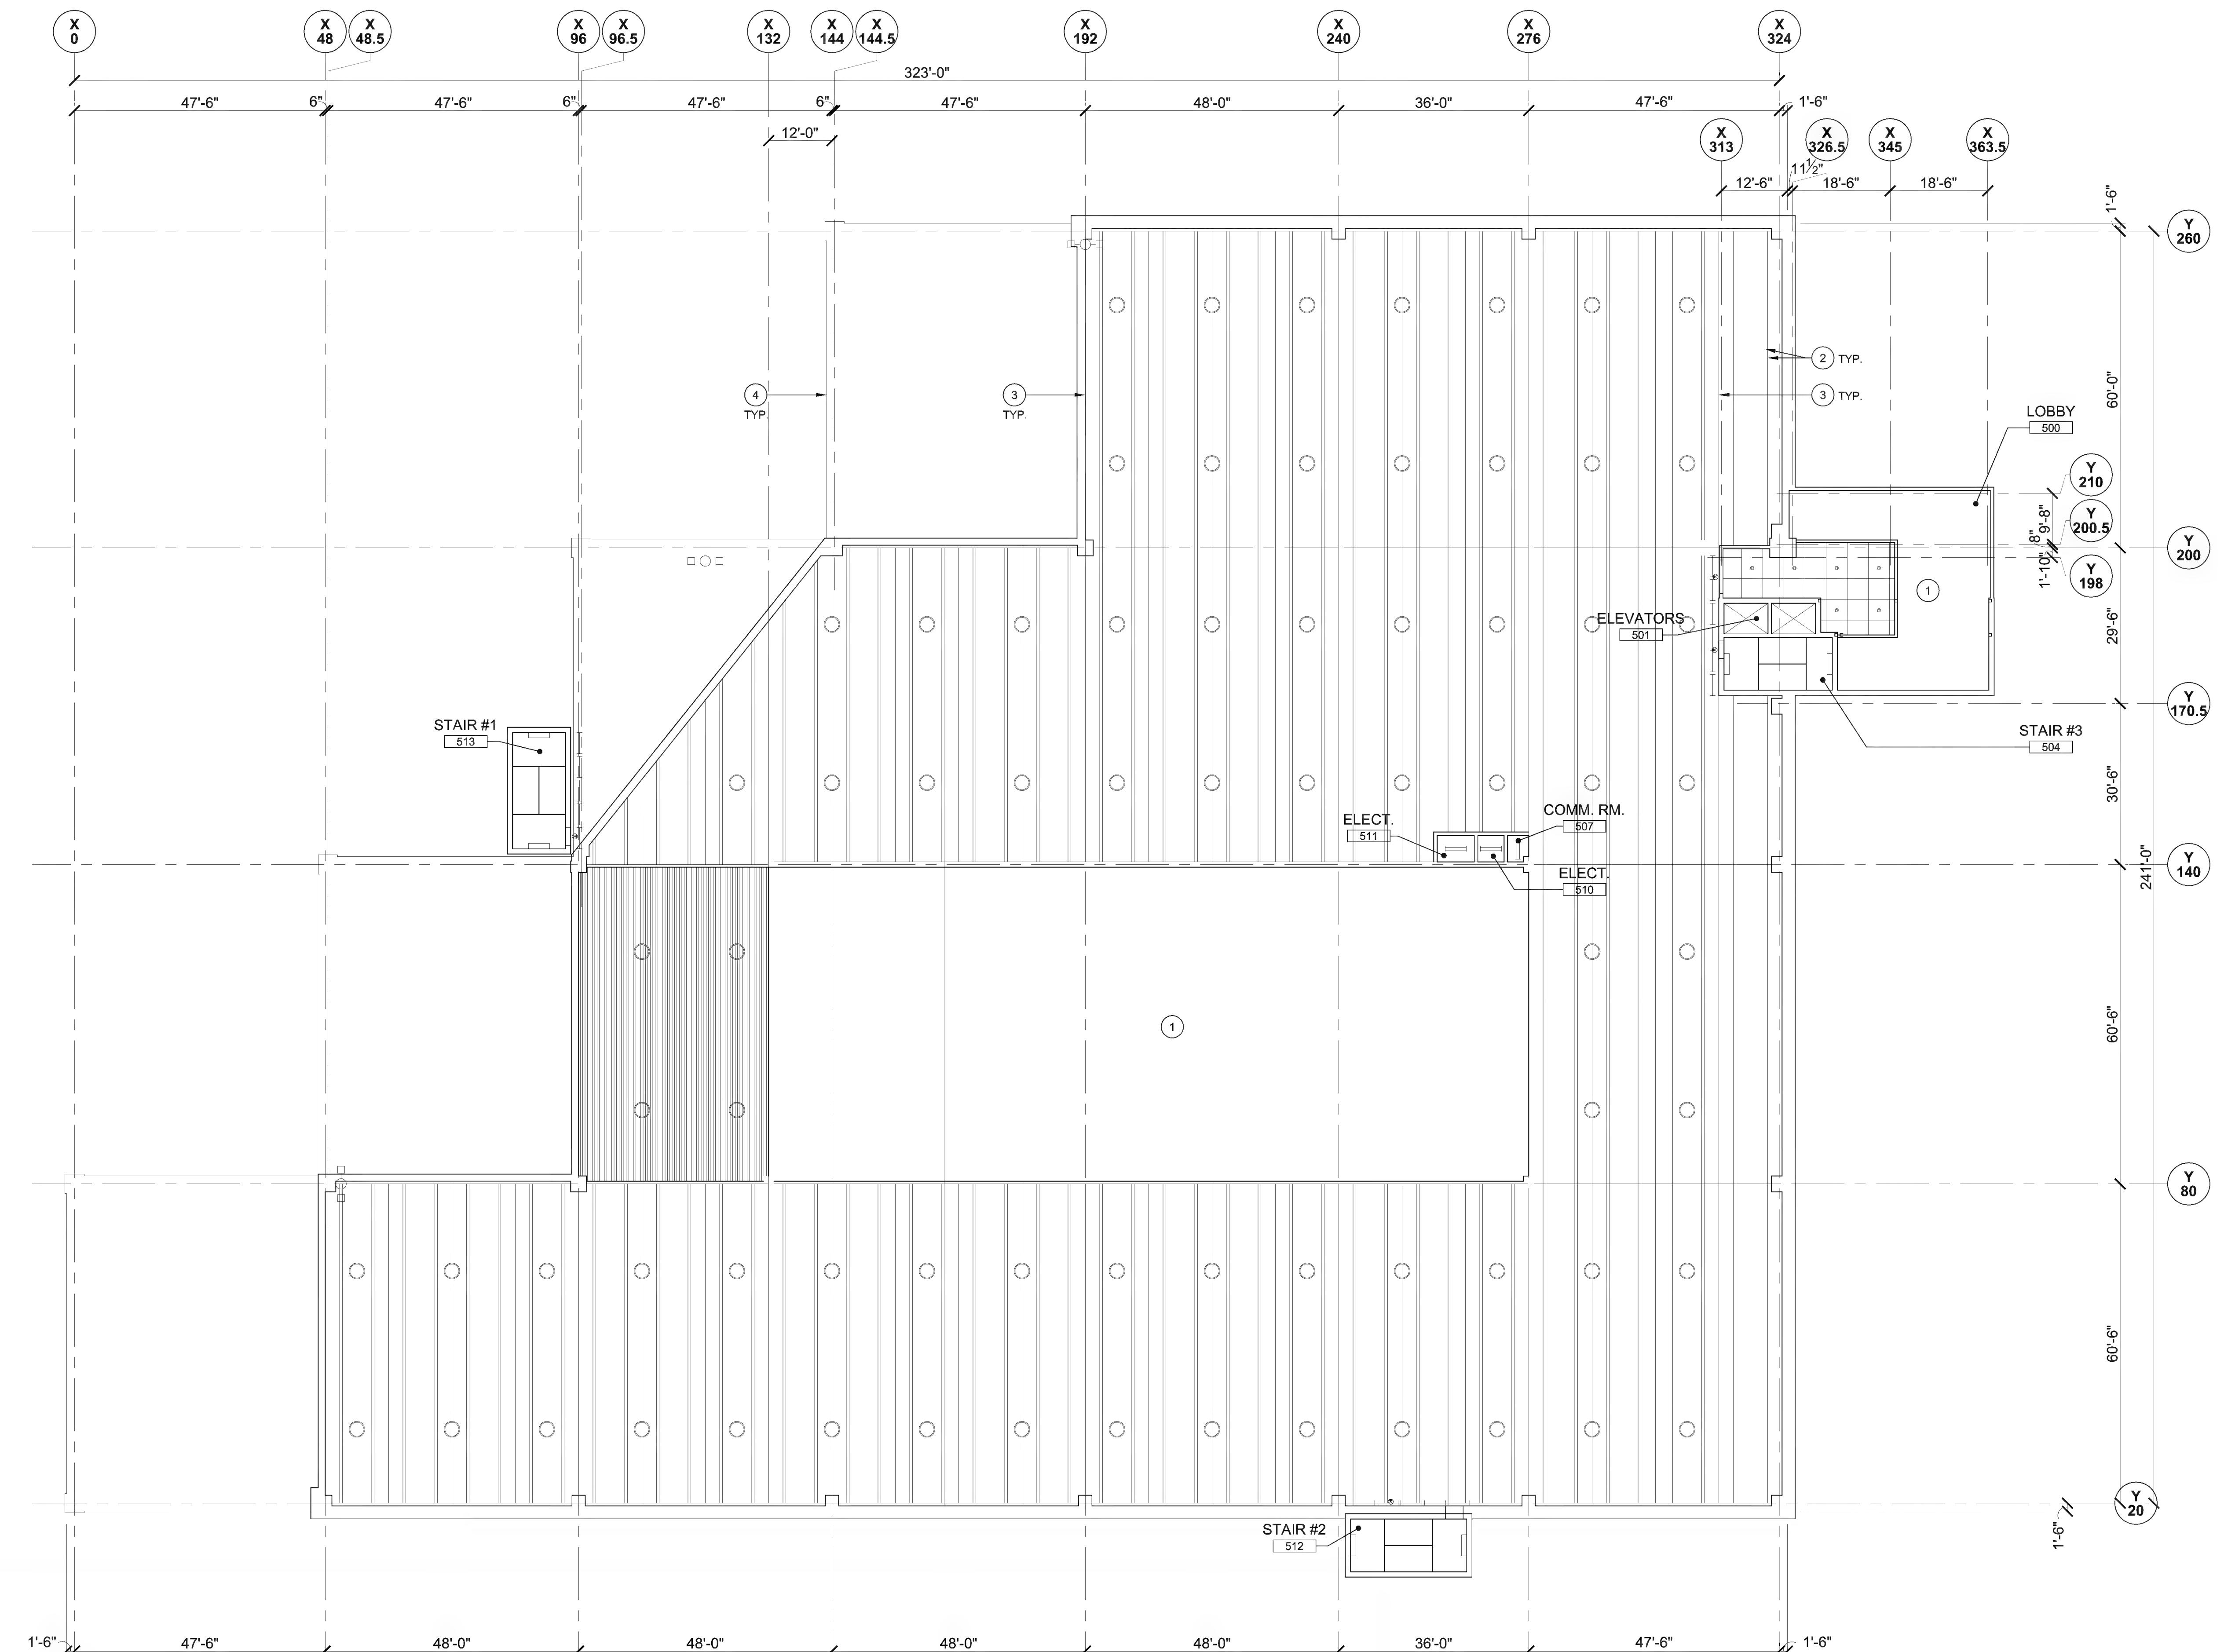
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01 | FOURTH FLOOR  
REFLECTED CEILING PLAN

1/16" = 1'-0"

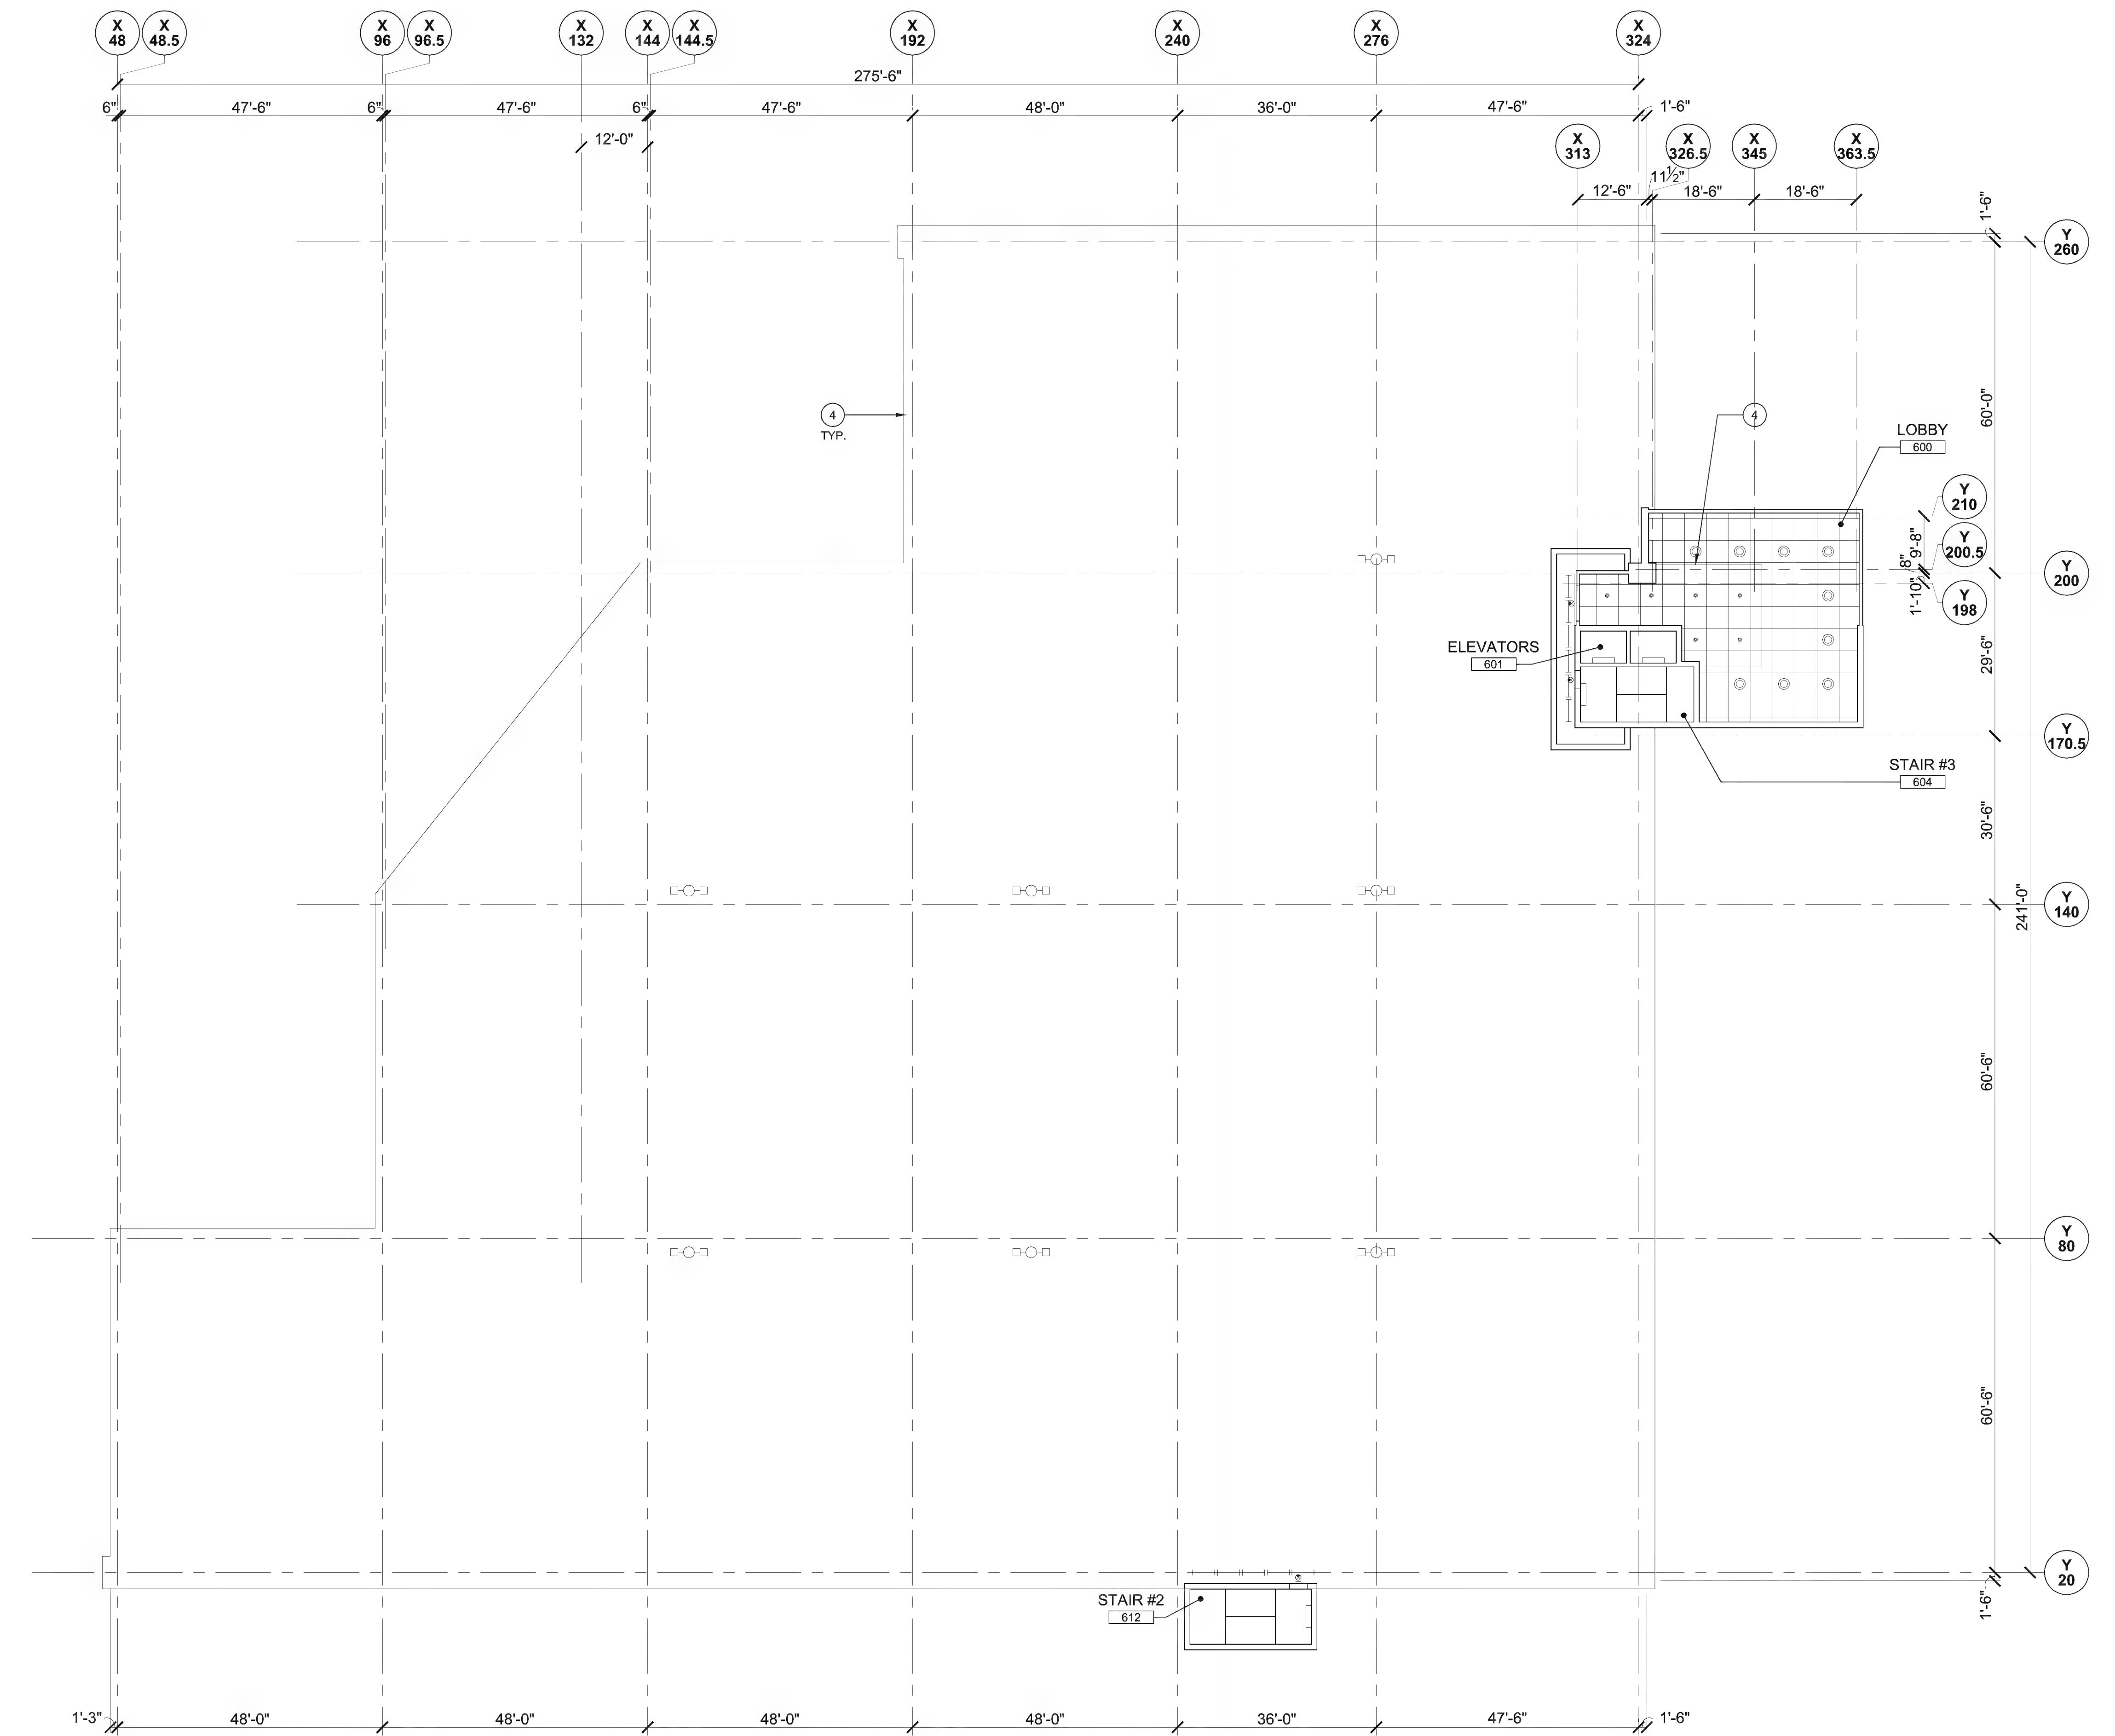
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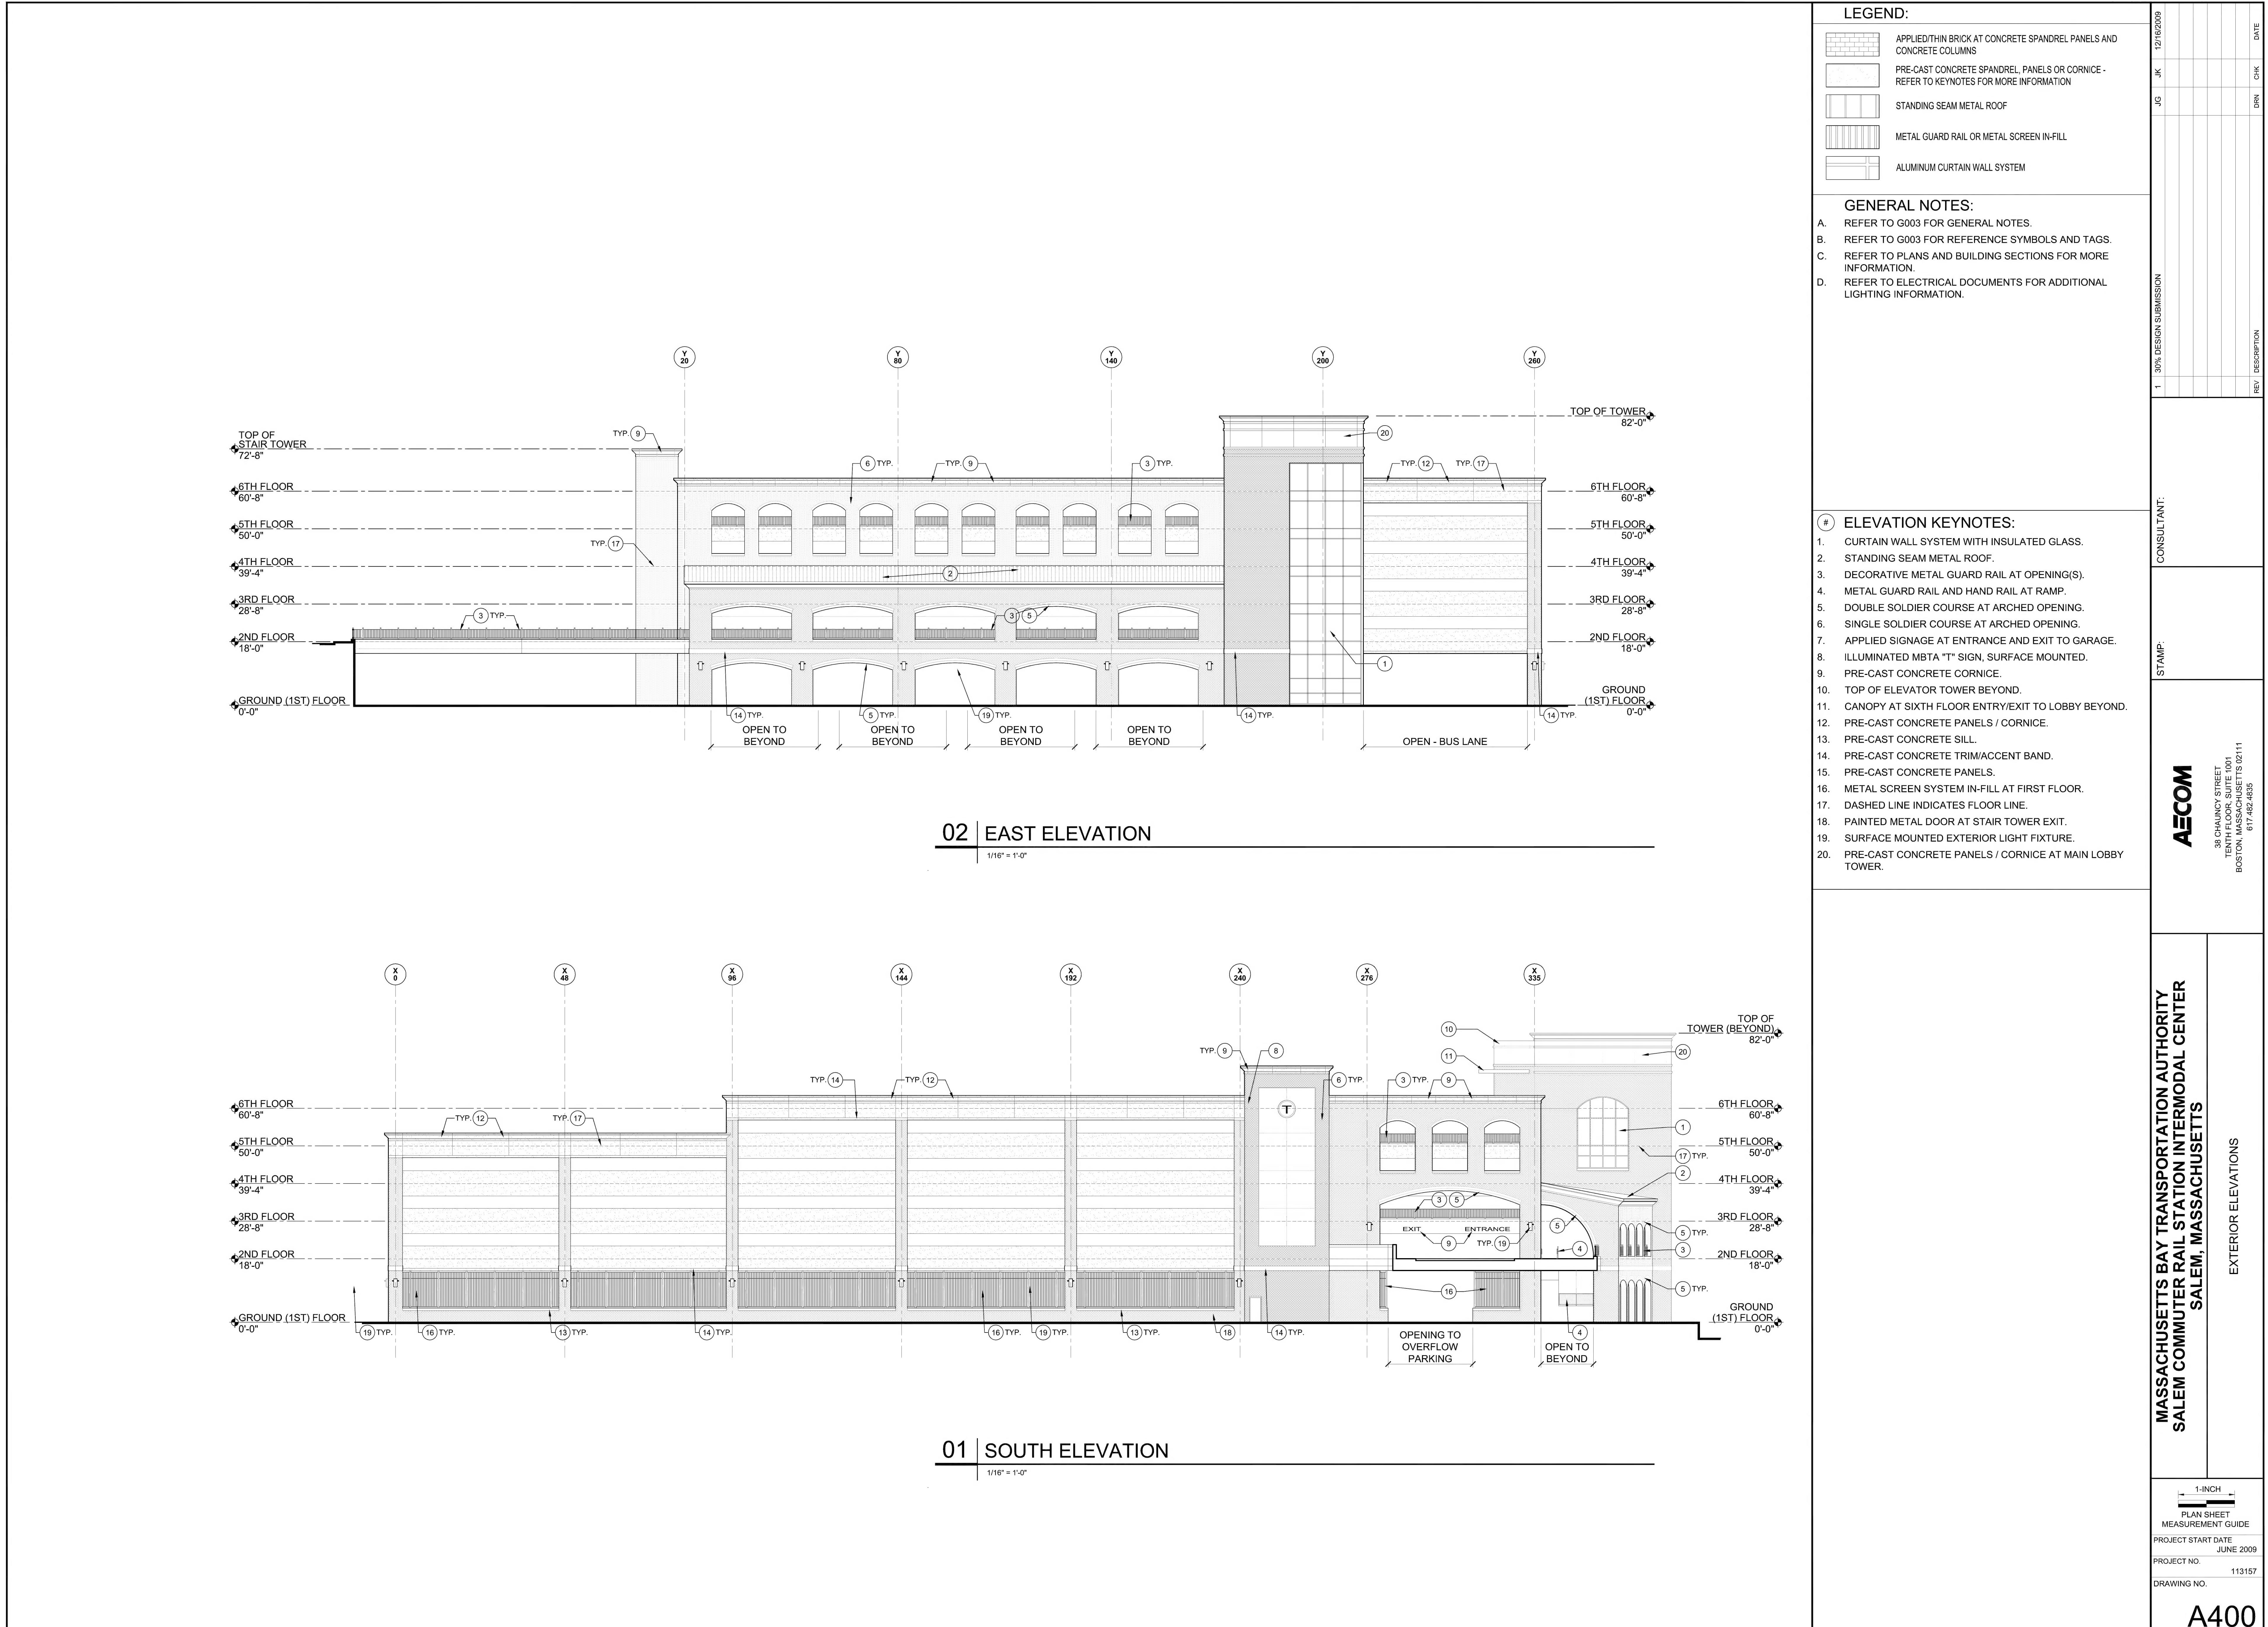
01 | FIFTH FLOOR  
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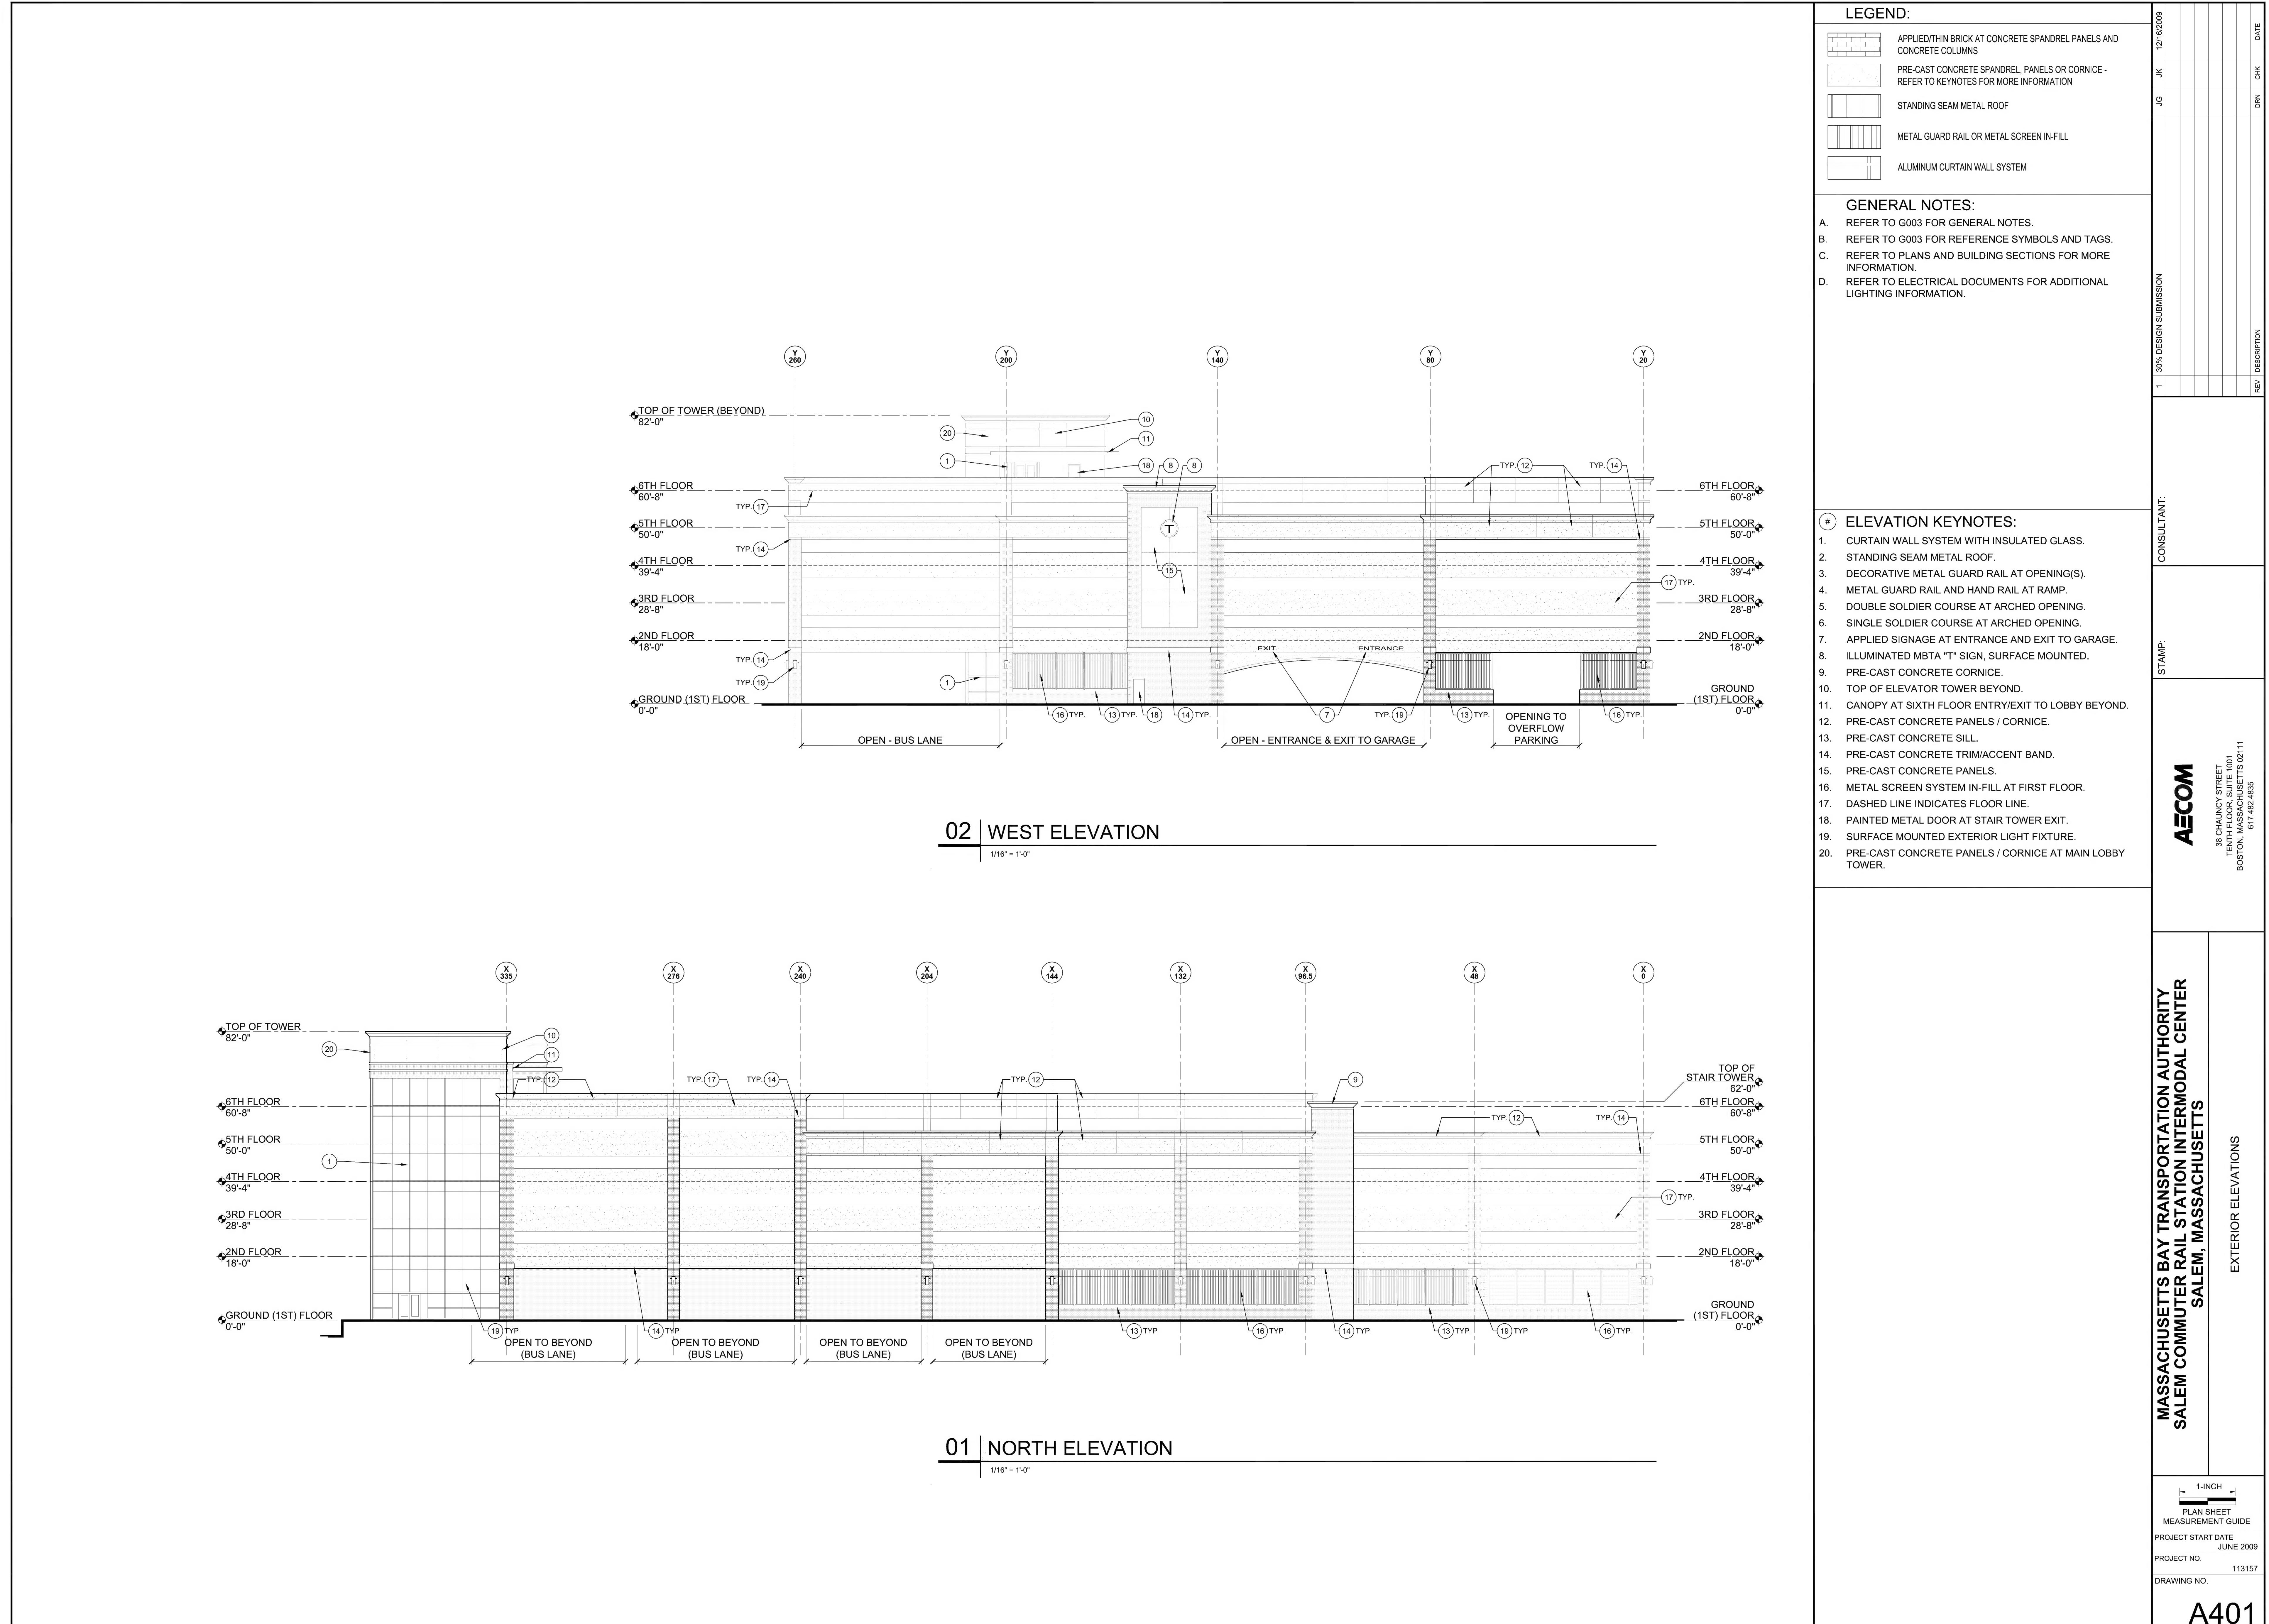
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SIXTH FLOOR REFLECTED CEILING PLAN		PLAN SHEET MEASUREMENT GUIDE 1-INCH PROJECT START DATE JUNE 2009 PROJECT NO. 113157 DRAWING NO.	





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